

PARK CITY PLANNING DEPARTMENT ADMINISTRATIVE PUBLIC HEARING MEETING SUMMIT COUNTY, UTAH April 20, 2023

REGULAR AGENDA - 12:00 PM

475 Woodside Avenue – Historic District Design Review – The Applicant Seeks to Demolish an Existing Single-Family Dwelling and Construct a New Single-Family Dwelling on a Steep Slope in the Historic Residential - 1 (HR-1) District. PL-22-05311

(A) Public Hearing, and (B) Action 475 Woodside Ave HDDR Staff Report

Exhibit A: 475 Woodside Ave HDDR Final Action Letter

Exhibit B: Proposed Plans

Exhibit C: 475 Woodside Ave Amended Plat

475 Woodside Avenue - Steep Slope Conditional Use Permit - The

Applicant Seeks to Demolish an Existing Single-Family Dwelling and Construct a New Single-Family Dwelling on a Steep Slope in the Historic Residential-1 (HR-1) Zoning District. PL-23-05585

(A) Public Hearing; (B) Action

475 Woodside Ave SSCUP Staff Report

Exhibit A: 475 Woodside SSCUP Final Action Letter

Exhibit B: Proposed Plans

Exhibit C: 475 Woodside Ave Amended Plat

Pursuant to the Americans with Disabilities Act, individuals needing special accommodations during the meeting should notify the Planning Department at 435-615-5060 or planning@parkcity.org at least 24 hours prior to the meeting.

*Parking is available at no charge for Council meeting attendees who park in the China Bridge parking structure.

Planning Department Staff Report

Subject: 475 Woodside Avenue

Application: PL-22-05311 Author: Caitlyn Tubbs,

Sr. Historic Preservation Planner

Date: April 20, 2023

Type of Item: Historic District Design Review (HDDR)

Recommendation

(I) Review the proposed Historic District Design Review for a new Single-Family Dwelling at 475 Woodside Avenue, (II) conduct a public hearing, and (III) consider approving the proposed Historic District Design Review based on the Findings of Fact, Conclusions of Law, and Conditions of Approval outlined in the Draft Final Action Letter (Exhibit A).

Description

Applicant: Ben and Holly Hoch, represented by Richard Krantz

Location: 475 Woodside Avenue

Zoning District: Historic Residential -1 (HR-1) Adjacent Land Uses: Residential, Open Space

Reason for Review: LMC <u>§15-1-8</u> delegates approval of HDDR applications for

new infill construction in Historic Zoning Districts to the

Planning Director.

HDDR Historic District Design Review HPB Historic Preservation Board

HR-1 Historic Residential-1
HSI Historic Sites Inventory
LMC Land Management Code

PCMC Park City Municipal Corporation
SSCUP Steep Slope Conditional Use Permit

Terms that are capitalized as proper nouns throughout this staff report are defined in LMC § 15-15-1.

Summary

475 Woodside Avenue is in the Historic Residential 1 (HR-1) Zoning District and an existing A-frame Structure is located on the site. The existing Structure is not listed on the Historic Sites Inventory (HSI) and was constructed in 1966. The Applicant has proposed demolition of the existing Structure and the construction of a new Single-Family Dwelling (SFD).

Background

The Applicant submitted a Historic District Design Review application on July 13, 2022. The Applicant provided an updated plans submittal on October 11, 2022, and another



on December 16, 2022. Planning Staff brought the proposal to the Design Review Team (DRT) on January 25, 2023, where the Applicant was in attendance. Following the meeting with the DRT the Applicant submitted an updated set of plans on February 3, 2023. On February 28, 2023, the Applicant submitted a Steep Slope Conditional Use Permit (SSCUP) application due to the steepness of the slope on the site.

<u>Analysis</u>

The Planning Director has the authority to take Final Action HDDR applications for new infill developments.¹ Staff has outlined the applicable regulations and analyzed the proposal's compliance in the following tables.

(I) Historic Residential (HR-1) Zoning District Requirements – LMC Chapter <u>15-2.2</u>

LMC §15-2.2-3: Lot and Size Requirements

Requirement	Analysis of Proposal
A. Lot Size:	Complies – The Lot is 37.5 feet in width and 75 feet in depth resulting in a Lot Area of 2,812.5 square
Minimum Lot Area for a	feet.
Single-Family Dwelling is	
1,875 square feet.	
B. Lot Width:	Complies – The existing Lot is 37.5 feet in width measured 15 feet from the Front Lot Line.
Minimum Lot width is twenty-	
five feet (25') measured	
fifteen feet (15') from the	
Front Lot Line.	
E. Building Footprint:	Complies – The proposed footprint of the Structure is 1,165.5 square feet.
The maximum Building	
Footprint for a 37.5 x 75 foot	
lot is 1,201 square feet.	
F. Front Setback:	Complies – The Structure is set back approximately twelve feet (12') from the Front Lot Line. An
10 feet	uncovered staircase encroaches into the front
	setback by ten feet (10') and abuts the Front Lot Line
	as permitted by LMC §15-2.2-3(G)(2). The stairs are
	no more than four feet (4') above Final Grade.
F. Rear Setback:	Complies with Condition of Approval 14 – The
	proposed Structure is sited 16 feet from the Rear Lot
10 feet	Line. The Applicant has proposed the construction of

¹ LMC §15-1-8.

_

	a ski bridge connecting the top floor of the SFD to the slope of the open space abutting the property. Patios, decks, pathways, steps, or similar Structures may only be 30 inches above Final Grade and must be a minimum of 1 foot from the property line. The proposed ski bridge abuts the Rear Lot Line and is approximately 6 inches from the top of the rear retaining wall. Staff recommends a condition of approval that the Applicant revise the design of the ski bridge to comply with LMC § 15-2.2-3(H).
I. Side Setbacks:	Complies – The Structure is set back three feet from both side Lot Lines. The roof eaves encroach into the
3 feet each	setback by one foot on each side; an encroachment
	of two feet is permitted by LMC §15-2.2-3(J)(4).

LMC §15-2.2-5: Building Height

Requirement	Analysis of Proposal
No structure shall be erected to a height greater than twenty-seven feet (27') from Existing Grade.	The proposed Structure is between nine feet two inches (9' 2") and twenty-five feet five inches (25' 5") from Existing Grade.
A. A Structure shall have a maximum height of thirty-five feet (35') measured from the lowest finish floor plane to the point of the highest wall top plate that supports the ceiling joists or roof rafters.	The Structure is exactly thirty-five feet (35') from the lowest finish floor plane to the highest wall top plate.
B. A ten foot (10') minimum horizontal step in the downhill façade is required unless the First Story is located completely under the finish Grade on all sides of the Structure. The horizontal step shall take place at a maximum height of twenty three feet (23') from where the Building Footprint meets the lowest point of existing Grade.	A ten-foot (10') deep horizontal step has been included in the front (downhill) portion of the building. This step back is located at a height of 18 feet from Existing Grade.
C. The roof pitch of a Structure's Contributing Roof Form shall be between seven:twelve (7:12) and twelve:twelve (12:12) and shall occupy a minimum horizontal distance of 20 feet measured from the primary façade to the rear of the building, as viewed from the primary public right-of-way.	The Contributing Roof Form has a pitch of 7:12.

(II) Design Guidelines for New Residential Infill Construction in Historic Districts – LMC $\underline{\$15\text{-}13\text{-}8}$

Requirement	Analysis of Proposal
Universal Guidelines	•
 New infill residential buildings shall reflect the historic character simple building forms, unadorned materials, restrained ornamentation – of Park City's Historic 	Complies – The proposed Structure has been designed with a specific architectural style in mind and is compatible with, but does not mimic, Historic Structures in the District. The Structure has minimal ornamentation and includes compatible materials and building forms. The existing structure is non-historic and no Historic Sites or Structures will be affected by the proposed construction. The proposed SED is similar in size and mass with neighboring
Sites. 2. New infill residential buildings shall not directly imitate existing historic structures in Park City. Roof pitch, shape and configuration, as well as scale of building elements found on Historic Sites may be duplicated, but building elements such as moldings, cornice details, brackets, and porch supports shall not be directly imitated. Reconstruction of nonsurviving historic buildings is allowed. 3. A style of architecture shall be selected and all elevations of the new infill residential building shall be designed in a manner consistent with	SFD is similar in size and mass with neighboring buildings and is oriented to face Woodside Avenue like the rest of the neighborhood.
contemporary interpretation of the	

- chosen selected style. Stylistic elements shall not simply be applied to exteriors. Styles that never appeared in Park City shall be avoided. Styles that radically conflict with the character of Park City's Historic Sites shall also be avoided. Styles that never appeared in Park City shall be avoided.
- 4. New infill residential buildings shall differentiate from historic structures but be compatible with historic structures in materials, features, size, scale and proportion, and massing to protect the integrity of the Historic District as a whole. The massing of the new infill residential buildings shall be further broken up into volumes that reflect the original massing of historic buildings; larger masses shall be located at the rear of the lot.
- 5. Building and site design shall respect the existing topography, the character-defining site features, including existing trees and vegetation, and shall minimize cut, fill, and the use of retaining

- walls.
- 6. Exterior elements roofs, entrances, eaves, chimneys, porches, windows, doors, steps, garages, etc. of the new infill residential building shall be of human scale and shall be compatible with neighboring Historic Structures.
- 7. Scale and height of new infill residential buildings shall follow the predominant pattern and respect the architecture of the Streetscape or character area with special consideration given to Historic Sites.
- 8. Size and mass of a structure shall be compatible with the size of the site so that lot coverage, building bulk, and mass are compatible with Historic Sites within the Streetscape or character area.
- New construction activity shall not physically damage nearby Historic Sites.
- 10. New infill residential buildings shall reinforce visual unity within the context of the Streetscape or character area. The specific context of each Streetscape or character area is an

important feature of the Historic District. The context of each Streetscape or character area shall be considered in its entirety, as one would see it when standing on the street viewing both sides of the street for the entire length of the Streetscape or character area. Special consideration should be given to adjacent and neighboring Historic Sites in order to reinforce existing rhythms and patterns.

- 11. New materials should reflect the character of the Historic District. Sustainable technology is constantly changing resulting in new alternative materials. New alternative materials may be reviewed by the Design Review Team for compliance being judged on the following characteristics:
- Longevity (50 year lifespan)
- Energy performance
- Durable in this climate
- Environmental benefit (high recycled content, locally sourced)
- Compatibility with the character of the

1 1		D :
Hieto	rıc	District
า แจเบ	IIC	DISHICL

Requirement	Analysis of Proposal
Specific Guidelines	
Building Setback and Orientation	Complies – The proposed SFD is compliant with the required setbacks and is oriented toward Woodside Avenue similarly to neighboring structures.
Topography and Grading	Complies – The proposed structure steps up the site as the hillside rises. The Applicant has proposed some additional grading in the rear yard to provide an outdoor living area but has preserved the slope around the perimeter of the site. As demonstrated in the provided Site Plan, the proposed grading changes are within two feet (2') of Existing Grade.
	1120 00 1121 00 1122 00 1123
	1125.00' 1124.00' 1125.00' 112
Landscaping and Vegetation	Complies with Condition of Approval 13 – The

	existing landscaping is minimal and consists of two large deciduous trees and native grasses. The two trees are planned to be removed as permitted by LMC § 15-13-8(B)(1)(c)(2). The Applicant has proposed the planting of dozens of shrubs, grasses, and perennials. The Applicant has also proposed the planting of a dwarf scotch pine and a maple. The proposed landscaping includes water-wise drip irrigation. Staff recommends a Condition of Approval that the Applicant will calculate the caliper of the existing mature trees on the Site and replace them with an equivalent (or greater) caliper of tree(s) as stated in LMC § 15-13-8(B)(1)(c).
Retaining Walls	Complies with Condition of Approval 15 – There are two existing walls directly out front of the current Structure which extend into the public right-of-way. These walls are approximately 8 feet tall and will be removed. The Applicant has proposed the installation of two garden retaining walls at the front of the structure which are approximately 6 feet in height. These walls will be clad in a stacked stone. The Applicant has also proposed a terraced retaining wall in the rear yard; each section of the wall will be 4 feet tall and clad in the same stacked stone. These walls are not located within the required side setback, but the northernmost wall encroaches into the required front setback. The portion of the northern retaining wall within the setback will be six feet (6') on the driveway side of the wall and less than one foot on the hillside side of the wall. LMC §15-4-2(A)(1) states the height of a retaining wall may exceed four feet (4') within the Front Setback with approval by the Planning Director and the City Engineer. Additionally, these walls encroach into the public right-of-way, Woodside Avenue, by five feet (5'). Staff recommends a Condition of Approval that the property owner obtain an encroachment agreement, or other appropriate instrument, from the Engineering Department allowing the placement of these walls within the right-of-way prior to the issuance of a building permit.
Fences	Not Applicable – The Applicant has not proposed
	the installation of fencing.
Paths, Steps, Handrails, & Railings (Not Associated with	Complies – The proposed walkways and handrails are subordinate to the main structure and are
Porches)	unobtrusive in appearance. The stairs in the rear

	yard will be clad in the same stacked stone to
	minimize the mix of outdoor materials.
Gazebos, Pergolas, and	Not Applicable – the Applicant is not proposing any
other Shade Structures	gazebos, pergolas, or shade structures with this
Office Office Office office	project.
Parking Areas & Driveways	Complies – The Applicant has provided two off-
l arking Areas & Driveways	street parking spaces within a single-wide tandem
	garage. Two off-street parking spaces are required
	for SFDs per LMC §15-3-6. The maximum driveway
	width permitted per LMC <u>§15-13-8(B)(1)(h)</u> is twelve
	feet (12'). The proposed driveway is eleven feet and
Drive on a Chranch and	seven inches (11' 7") in width.
Primary Structures	Complied The proposed CFD is compliant with the
Mass, Scale & Height	Complies – The proposed SFD is compliant with the
	required setbacks, building footprint, and building
	height requirements of the HR-1 Zoning District. It is
	similar in mass and scale with surrounding structures
	and has a solid-to-void ratio that is compatible with
Foundation	the surrounding Historic District.
Foundation	Complies – The Applicant has proposed a
	foundation clad in a stone veneer. There is a clear
	change in materials between the foundation and the
Deere	walls above.
Doors	Complies – The proposed SFD has a prominent
	front entry and has a door pattern on the main level
	that compliments the Historic District. The design and
	material of the wood doors is similar to those seen
I and the second	alcowhere in the Historia District
Windows	elsewhere in the Historic District.
Windows	Complies – The proposed windows are compatible
Windows	Complies – The proposed windows are compatible with the character of the Historic District and the
Windows	Complies – The proposed windows are compatible with the character of the Historic District and the surrounding neighborhood. They have a 2:1
Windows	Complies – The proposed windows are compatible with the character of the Historic District and the surrounding neighborhood. They have a 2:1 dimension and maintain a solid-to-void ratio that is
	Complies – The proposed windows are compatible with the character of the Historic District and the surrounding neighborhood. They have a 2:1 dimension and maintain a solid-to-void ratio that is similar to Structures within the Historic District.
Windows	Complies – The proposed windows are compatible with the character of the Historic District and the surrounding neighborhood. They have a 2:1 dimension and maintain a solid-to-void ratio that is similar to Structures within the Historic District. Complies – The proposed roof has a pitched form
	Complies – The proposed windows are compatible with the character of the Historic District and the surrounding neighborhood. They have a 2:1 dimension and maintain a solid-to-void ratio that is similar to Structures within the Historic District. Complies – The proposed roof has a pitched form with a 7:12 slope. Secondary roof forms are shed
	Complies – The proposed windows are compatible with the character of the Historic District and the surrounding neighborhood. They have a 2:1 dimension and maintain a solid-to-void ratio that is similar to Structures within the Historic District. Complies – The proposed roof has a pitched form with a 7:12 slope. Secondary roof forms are shed roofs with the same slope. These forms and slope
	Complies – The proposed windows are compatible with the character of the Historic District and the surrounding neighborhood. They have a 2:1 dimension and maintain a solid-to-void ratio that is similar to Structures within the Historic District. Complies – The proposed roof has a pitched form with a 7:12 slope. Secondary roof forms are shed roofs with the same slope. These forms and slope are typical on Historic Structures and infill Structures
	Complies – The proposed windows are compatible with the character of the Historic District and the surrounding neighborhood. They have a 2:1 dimension and maintain a solid-to-void ratio that is similar to Structures within the Historic District. Complies – The proposed roof has a pitched form with a 7:12 slope. Secondary roof forms are shed roofs with the same slope. These forms and slope are typical on Historic Structures and infill Structures within the Historic District. The proposed roofing
	Complies – The proposed windows are compatible with the character of the Historic District and the surrounding neighborhood. They have a 2:1 dimension and maintain a solid-to-void ratio that is similar to Structures within the Historic District. Complies – The proposed roof has a pitched form with a 7:12 slope. Secondary roof forms are shed roofs with the same slope. These forms and slope are typical on Historic Structures and infill Structures within the Historic District. The proposed roofing material is metal which is an appropriate material per
Roofs	Complies – The proposed windows are compatible with the character of the Historic District and the surrounding neighborhood. They have a 2:1 dimension and maintain a solid-to-void ratio that is similar to Structures within the Historic District. Complies – The proposed roof has a pitched form with a 7:12 slope. Secondary roof forms are shed roofs with the same slope. These forms and slope are typical on Historic Structures and infill Structures within the Historic District. The proposed roofing material is metal which is an appropriate material per LMC § 15-13-8(B)(2)(E).
	Complies – The proposed windows are compatible with the character of the Historic District and the surrounding neighborhood. They have a 2:1 dimension and maintain a solid-to-void ratio that is similar to Structures within the Historic District. Complies – The proposed roof has a pitched form with a 7:12 slope. Secondary roof forms are shed roofs with the same slope. These forms and slope are typical on Historic Structures and infill Structures within the Historic District. The proposed roofing material is metal which is an appropriate material per LMC § 15-13-8(B)(2)(E). Complies – The proposed dormers are compatible in
Roofs	Complies – The proposed windows are compatible with the character of the Historic District and the surrounding neighborhood. They have a 2:1 dimension and maintain a solid-to-void ratio that is similar to Structures within the Historic District. Complies – The proposed roof has a pitched form with a 7:12 slope. Secondary roof forms are shed roofs with the same slope. These forms and slope are typical on Historic Structures and infill Structures within the Historic District. The proposed roofing material is metal which is an appropriate material per LMC § 15-13-8(B)(2)(E). Complies – The proposed dormers are compatible in scale with the overall roof form and are centralized
Roofs	Complies – The proposed windows are compatible with the character of the Historic District and the surrounding neighborhood. They have a 2:1 dimension and maintain a solid-to-void ratio that is similar to Structures within the Historic District. Complies – The proposed roof has a pitched form with a 7:12 slope. Secondary roof forms are shed roofs with the same slope. These forms and slope are typical on Historic Structures and infill Structures within the Historic District. The proposed roofing material is metal which is an appropriate material per LMC § 15-13-8(B)(2)(E). Complies – The proposed dormers are compatible in scale with the overall roof form and are centralized over the front door and balcony. They are set back
Roofs	Complies – The proposed windows are compatible with the character of the Historic District and the surrounding neighborhood. They have a 2:1 dimension and maintain a solid-to-void ratio that is similar to Structures within the Historic District. Complies – The proposed roof has a pitched form with a 7:12 slope. Secondary roof forms are shed roofs with the same slope. These forms and slope are typical on Historic Structures and infill Structures within the Historic District. The proposed roofing material is metal which is an appropriate material per LMC § 15-13-8(B)(2)(E). Complies – The proposed dormers are compatible in scale with the overall roof form and are centralized over the front door and balcony. They are set back from the frontmost wall of the Structure and are
Roofs	Complies – The proposed windows are compatible with the character of the Historic District and the surrounding neighborhood. They have a 2:1 dimension and maintain a solid-to-void ratio that is similar to Structures within the Historic District. Complies – The proposed roof has a pitched form with a 7:12 slope. Secondary roof forms are shed roofs with the same slope. These forms and slope are typical on Historic Structures and infill Structures within the Historic District. The proposed roofing material is metal which is an appropriate material per LMC § 15-13-8(B)(2)(E). Complies – The proposed dormers are compatible in scale with the overall roof form and are centralized over the front door and balcony. They are set back

	Applicant has not proposed any gutters or
	Applicant has not proposed any gutters or downspouts at this time. Staff recommends a
	Condition of Approval that any gutters or downspouts
	comply with the requirements outlined within LMC
	<u>§15-13-8</u> .
Chimneys and Stovepipes	Not Applicable – The Applicant has not proposed
	any chimneys or stovepipes for this home.
Porches	Complies – The proposed front porch extends the
	full width of the proposed Structure and includes a
	gable over the front door. The proposed columns are
	square and unadorned and are compatible with the
Angleita atumal Factures	Historic District.
Architectural Features	Complies – Overall, the design of the house is
	simple with minimal ornamentation. Decorative shingles are proposed in the gable over the front
	door which would be a traditional location for
	decoration on Historic Structures.
Mechanical and Utility	Complies with Condition of Approval 7– The
Systems and Service	Applicant has not proposed the location(s) of
Equipment	mechanical or utility systems or equipment at this
	point. Staff recommends a Condition of Approval that
	when these mechanical systems or equipment are
	installed they be required to comply with LMC § 15-
	13-8(B)(3) and LMC § 15-2.2-3.
Materials	Complies – The Applicant has proposed wood siding
	with sections of board-and-batten and stone veneer
	which are common on Historic Structures and new
Paint and Color	infill construction alike. Complies with Condition of Approval 6 – A paint
	or stain color has not yet been selected for the
	proposed board-and-batten or shiplap siding. Staff
	recommends a Condition of Approval that the siding
	shall have an opaque rather than transparent finish
	per LMC §15-13-8(B)(5).
Garages	Complies – The proposed parking is provided within
	a two-car tandem garage. The proposed garage is
	located in the basement level of the house and does
	not extend past the frontmost wall plane of the
	Structure. Garages in SFDs must have a minimum
	interior dimension of eleven feet (11') wide by twenty
	feet (20') deep per LMC <u>\$15-3-4(A)(1)</u> . The proposed
	garage has an interior dimension of eleven feet (11') by thirty-six feet (36').
Decks	Not Applicable – No decks are proposed with this
20010	SFD.
Balcony and Roof Decks	Complies – The proposed balcony on the front of the
, ,	

	Structure has been clad in the same shiplap siding utilized on the majority of the SFD, visually minimizing it from view. The balcony located on the rear of the SFD is not visible from the public right-ofway.
New Accessory Structures	Not Applicable – The Applicant is not proposing any
	accessory structures.
Additions to Existing Non- Historic Structures	Not Applicable – While there is an existing non- historic structure on the site the Applicant is not proposing to construct an addition to an existing
	home.
Reconstruction of Non-	Not Applicable – The Applicant is not proposing the
Surviving Structures	reconstruction of a non-surviving historic structure.

Notice

Staff published notice on the City's website and the Utah Public Notice website and posted notice to the property on April 5, 2023. Staff mailed courtesy notice to property owners within 100 feet on April 5, 2023.

Public Input

Staff did not receive any public input at the time this report was published.

Alternatives

- The Planning Director may approve the Historic District Design Review;
- The Planning Director may deny the Historic District Design Review and direct staff to make Findings for the denial; or
- The Planning Director may request additional information and continue the discussion to a date certain/uncertain.

Exhibits

Exhibit A: Draft Final Action Letter

Exhibit B: Proposed Plans

Exhibit C: 475 Woodside Avenue Amended Plat



April 20, 2023

Ben and Holly Hoch 842 Emerald Bay Laguna Beach, CA 92651 949-752-6345

CC: Richard Krantz

NOTICE OF PLANNING DIRECTOR ACTION

Description

Address: 475 Woodside Avenue

Zoning District: Historic Residential (HR-1) District

Application: Historic District Design Review (HDDR)

Project Number: PL-22-05311 (HDDR)

Action: APPROVED WITH CONDITIONS (See Below)

Date of Final Action: Thursday April 20, 2023

Project Summary: Applicant seeks to demolish an existing Single-Family

Dwelling and construct a new Single-Family Dwelling on a Steep Slope within the Historic Residential (HR-1) District.

Action Taken

On April 20, 2023, the Planning director conducted a public hearing and approved the Historic District Design Review to demolish an existing Single-Family Dwelling and construct a new Single-Family Dwelling on a Steep Slope within the Historic Residential (HR-1) District at 475 Woodside Avenue according to the following findings of fact, conclusions of law, and conditions of approval.

Findings of Fact

- 1. The Site is located at 475 Woodside Avenue.
- 2. The Site is Lot 1 in the 475 Woodside Avenue Amended Plat, recorded at the Summit County Recorder's Office on July 7, 1999 (Entry #543463).
- 3. The Site is located within the Historic Residential (HR-1) District.



- 4. There is an existing Single-Family Dwelling on the Lot and the Applicant proposes to demolish it and construct a new Single-Family Dwelling.
- 5. The existing Single-Family Dwelling was constructed in 1966 and is not listed on the Historic Sites Inventory (HSI).
- 6. The required setbacks are 10 feet in the front, 10 feet in the rear and 3 feet in the sides.
- 7. The proposed structure is compliant with the HR-1 District setbacks; it is 12 feet from the Front Lot Line, 16 feet from the Rear Lot Line, and 3 feet from both Side Lot Lines.
- 8. The allowable maximum building footprint in the HR-1 District on a Lot of this size is 1,201 square feet.
- 9. The proposed building footprint is 1,165.5 square feet.
- 10. The allowable maximum building height in the HR-1 District is 27 feet.
- 11. The proposed Structure is 25 feet 5 inches in height.
- 12. LMC §15-3-6(A) requires two Off-Street parking spaces for SFDs.
- 13. The proposed Structure includes two Off-Street parking spaces within a tandem garage.
- 14. The maximum driveway width permitted per LMC §15-13-8(B)(1)(h) is twelve feet (12').
- 15. The proposed driveway is eleven feet and seven inches (11' 7") in width.
- 16. Garages in SFDs must have a minimum interior dimension of eleven feet (11') wide by twenty feet (20') deep per LMC §15-3-4(A)(1).
- 17. The proposed garage has an interior dimension of eleven feet (11') by thirty-six feet (36').
- 18. Staff reviewed the 475 Woodside Avenue Historic District Design Review for compliance with LMC Chapter 15-2.2 Historic Residential Zoning District and Chapter 15-13-8 Design Guidelines.
- 19. The proposed Structure complies with the underlying requirements of the HR-1 Zoning District (LMC Chapter 15-2.2) and the Design Guidelines for New Residential Infill Construction in Historic Districts (LMC §15-13-8).
- 20. On April 5, 2023, City staff provided a public hearing notice to all property owners within 100 feet of the proposed HDDR and posted a sign to the subject property.
- 21. On April 5, 2023, City staff published a public hearing notice to the City website and to the Utah Public Notice website.

Conclusions of Law



- 1. The proposal complies with the LMC requirements pursuant to LMC Chapter 15-2.2 Historic Residential (HR-1) District.
- 2. The proposal complies with the criteria for the Design Guidelines for New Residential Infill Construction in Historic Districts outlined in LMC §15-13-8.

Conditions of Approval

- Final building plans and construction details shall be the same as the plans approved April 20, 2023 by the Planning Department. Any changes, modifications, or deviations from the approved design that have not been approved in advance by the Planning and Building Departments may result in a stop work order.
- 2. If the Applicant does not obtain a complete building permit within one year of the date of this approval, this HDDR approval will expire unless the Applicant submits a written extension request to the Planning Department prior to the expiration date and the Planning Department approves an extension.
- 3. The Applicant is responsible for notifying the Planning Department prior to making any changes to the approved plans.
- 4. Any changes, modifications, or deviations from the approved scope of work shall be submitted in writing for review and approval/denial in accordance with the applicable standards by the Planning Director or designee prior to construction.
- 5. The property is located outside of the Park City Landscaping and Maintenance of Soil Cover Ordinance (Soils Ordinance) and therefore not regulated by the City for mine-related impacts. If the property owner does encounter mine waste or mine waste impacted soils they must handle the material in accordance with State and Federal law.
- Any exterior wood shall have an opaque rather than transparent finish. When
 possible, low-VOC (volatile organic compound) paints and finishes shall be used.
 Rustic, unfinished wood is inappropriate.
- 7. All proposed mechanical equipment and/or hot tubs shall meet all setback requirements per LMC §15-2.2-3 and shall be screened with no hot tubs on front façade decks. If the equipment is located on a secondary façade, it shall be placed behind the midpoint of the structure or in a location that is not visible from the primary public right-of-way along Woodside Avenue. Ground-level equipment shall be screened using landscape elements such as low fences, low stone walls, or perennial plant materials.
- 8. Any areas disturbed during construction surrounding the proposed work shall be brought back to its original state.



- 9. Construction shall not impact surrounding historic structures.
- 10. Vinyl or aluminum doors and windows are prohibited.
- 11. Metal materials shall not be reflective.
- 12. All exterior lighting shall be down directed, fully shielded, and 3,000 degrees Kelvin or less to prevent glare onto adjacent property and public rights-of-way and shall comply with the City's outdoor lighting code per LMC §15-5-5(J). Final lighting details must be reviewed by Planning Staff prior to installation.
- 13. The Applicant shall calculate the caliper of the existing mature trees on the Site and replace them with an equivalent (or greater) caliper of tree(s) as required in LMC §15-13-8(B)(1)(c).
- 14. The Applicant shall revise the design of the proposed ski bridge in the rear of the Site to comply with LMC §15-2.2-3(H). If the bridge cannot be designed to comply with the LMC requirements it shall be removed from the plans.
- 15. The property owner shall obtain an encroachment agreement, or other appropriate instrument, from the Engineering Department allowing the placement of the garden walls encroaching into the public right-of-way up to five feet (5') prior to the issuance of a building permit.
- 14.16. Gutters and downspouts shall comply with the requirements outlined in LMC §15-13-8

If you have questions or concerns regarding this Final Action Letter, please call (435)-615-5063 or email caitlyn.tubbs@parkcity.org.

Sincerely,

Gretchen Milliken, Planning Director

CC: Caitlyn Tubbs, Sr. Historic Preservation Planner

LEGAL DESCRIPTION

LOT 1, 475 WOODSIDE AVENUE AMENDMENT A.P.N.: 475-1

Hoch Residence

475 Woodside Avenue Park City, UT 84060



VICINITY MAP



REVISION LOG

REV.	DATE	REASON
	•	

The services to be performed by the Architect/Engineer pursuant to this Agreement with the Owner are intended solely for the benefit of the Owner, and no benefit is conferred hereby, nor is any contractual relationship established herewith, upon or with any person or entity not a party to this Agreement. No such person or entity shall be entitled to rely on the Architect/Engineer's performance of its services hereunder, and no right to assert a claim against the Architect/Engineer, its officers, employees, agents, or consultants shall accrue to the Contractor or to any subcontractor, sub-subcontractor, independently retained professional consultant, applier, fabricator, manufacturer, lender, tenant, insurer, surety, or any other third party as a result of this Agreement or the performance or non-performance of the Architect/Engineer's services hereunder.

NOTE:

IT IS THE CONTRACTOR'S RESPONSIBILITY TO ENSURE THAT ALL HEAVY COSMETIC ARCHITECTURAL ELEMENTS HAVE STRUCTURAL SUPPORT DESIGNED BY A LICENSED STRUCTURAL ENGINEER. HEAVY COSMETIC ELEMENTS ARE THOSE ELEMENTS WHICH HAVE NOT BEEN ACCOUNTED FOR ON THE STRUCTURAL PLANS IN THIS SET. THESE MAY INCLUDE, BUT ARE NOT LIMITED TO, DECORATIVE BEAMS, FIREPLACE SURROUNDS, INTERIOR WALL AND CEILING MASONRY OR STONEWORK AND CHANDELIERS.

INDEX

STREETSCAPE ELEVATION AND PROPOSED ESTATE 3-D IMAGES

CURRENT PHOTOGRAPHS EXHIBIT DESIGN REFERENCE IMAGES

ARCHITECTURAL SITE PLAN

GARAGE AND MAIN LEVEL FLOOR PLANS MID AND UPPER LEVEL FLOOR PLANS

ROOF PLAN

BUILDING SECTIONS BUILDING SECTIONS

EXTERIOR ELEVATIONS EXTERIOR ELEVATIONS

LANDSCAPE SHEETS BY ARCSITIO DESIGN, INC.

GRADING PLAN LANDSCAPE PLAN

CIVIL PLANS BY FERRARI SURVEYING, LLC

ARCHITECTURAL DETAILS

RECORD OF SURVEY AND TOPOGRAPHICAL MAP

PROJECT DATA

OWNER

BEN AND HOLLY HOCH 842 EMERALD BAY LAGUNA BEACH, CA 92651 PH (949) 697-1560

SCOPE OF WORK

DEMOLISH EXISTING RESIDENCE AND CONSTRUCT A NEW 4-STORY SINGLE-FAMILY RESIDENCE WITH ATTACHED GARAGE.

475 WOODSIDE AVENUE PARK CITY, UT 84060 PROJECT ADDRESS:

OCCUPANCY: R3 / U

CONSTRUCTION TYPE: VB, (SPRINKLERED)

BUILDING CODES:

SQUARE FOOTAGE

TOTAL CONDITIONED AREA:

CONDITIONED AREA: GARAGE LEVEL: MAIN LEVEL: MID LEVEL: UPPER LEVEL: 663 SQ. FT. 1,002 SQ. FT. 857 SQ. FT. 578 SQ. FT.

UNCONDITIONED AREA:

TOTAL DECKS & PATIOS

GARAGE LEVEL PATIO: FRONT PORCH: MID DECK: 3,100 SQ. FT.

207 SQ. FT. 167 SQ. FT. 218 SQ. FT. 592 SQ. FT.

401 SQ. FT.

PLAN CHECK/ PERMIT FILE NUMBERS

GRADING PLAN:	MECHANICAL:
HOUSE PLANS:	PLUMBING:
RETAINING WALLS:	ELECTRICAL:

CONSULTANTS

THE OWNER OF THIS PROJECT HAS RETAINED THE CONSULTANTS BELOW TO PROVIDE DESIGN SERVICES IN THE INDIVIDUAL DISCIPLINES AS LISTED. ALL OF THE REPORTS, DRAWINGS OR CALCULATIONS OF THESE CONSULTANTS ARE NECESSARY FOR THE PROPER CONSTRUCTION OF THIS PROJECT. AS A CONDITION OF THE USE OF THESE PLANS, THE CONTRACTOR IS REQUIRED TO BE FAMILIAR WITH, AND TO MAINTAIN CURRENT COPIES OF THESE CONSULTANTS' DOCUMENTS ON THE JOB SITE.

LANDSCAPE ARCHITECT

ARCSITIO DESIGN, INC. 1058 EAST 2100 SOUTH SALT LAKE CITY, UT 84106

CONTACT: STEVEN GILBERT

(801) 487-4923 SGILBERT@ARCSITIODESIGN.COM

INTERIOR DESIGNER

CC & COMPANY DESIGNS 200 BRIGGS AVENUE COSTA MESA, CA 92626

CONTACT: COURTNEY ZIETHING

(949) 650-4222 CC&COMPANYDESIGNS@GMAIL.COM

SHEET NO.



Architecture

Richard

Sheet over

Avenue 84060 esidence Hoch

DRAWN CHECKED 2/3/2023 REVISION


SET NO.









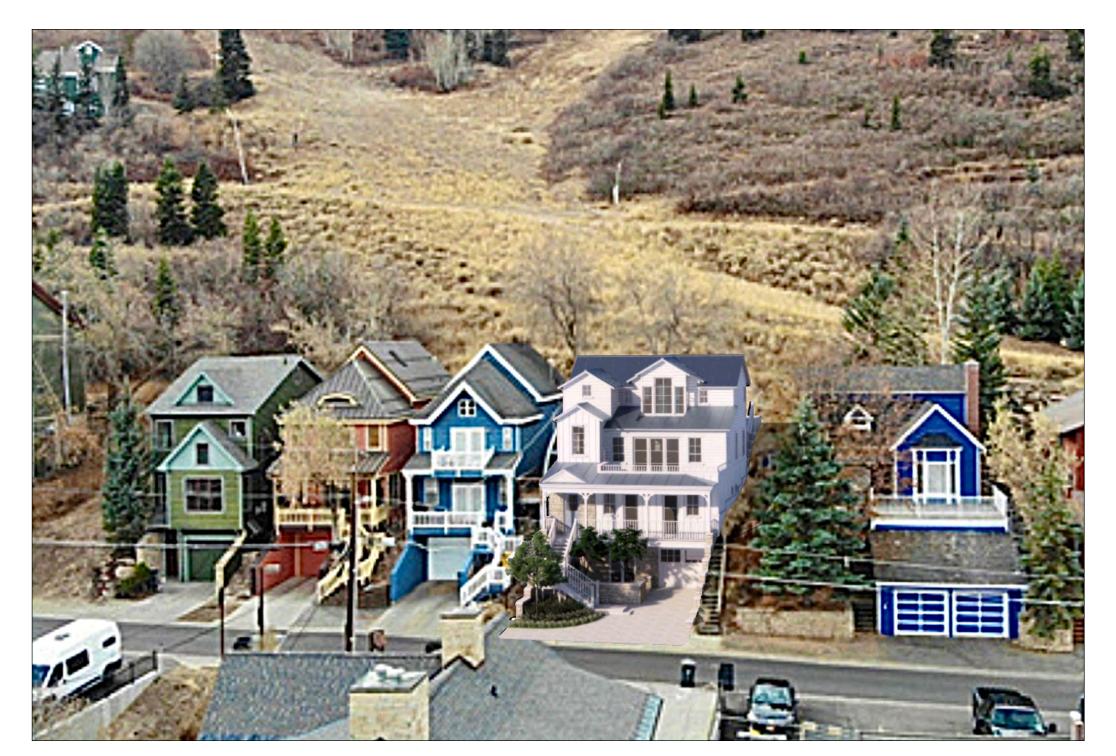



Streetscape Elevation







3D

DATE 2/3/2023 REVISION







Front View (Facing Toward Site)







Rear View (Facing Toward Site)





Rear View (Facing away from Site)



Left Side View (Facing away from Site)



Right Side View (Facing away from Site)





Aerial View



Front Aerial View

Hoch Residence


DATE 7/13/2022









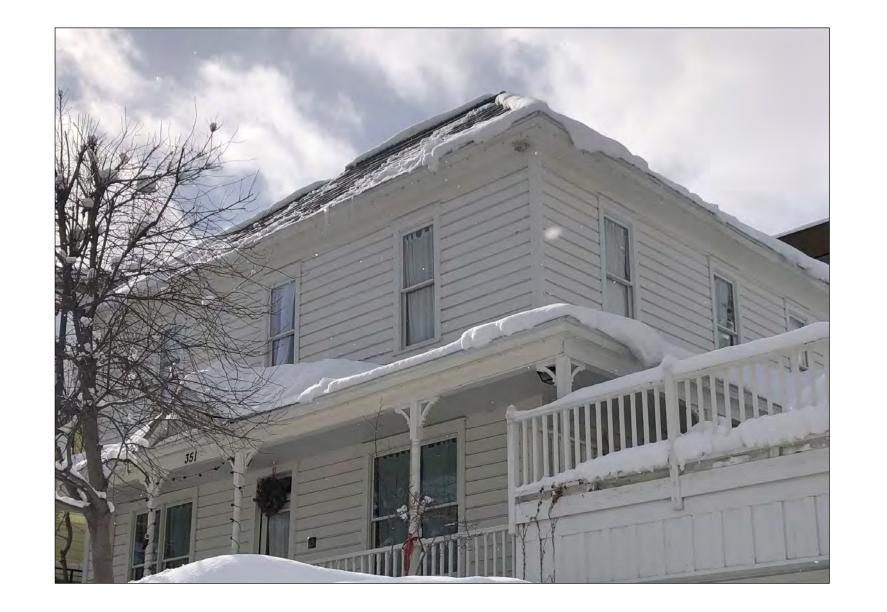



Design Reference Images


Richard Krantz Architecture, Inc.


Architecture / Planning
1500 Quail Street, Suite 520
Newport Beach, CA 92660
(949) 752-6345 Fax (949) 752-6235

475 Woodside Avenue Park City, UT 84060 Hoch Residence

D A T E
7/12/2022
R E V I S I O N SET NO. SHEET NO.


CHECKED

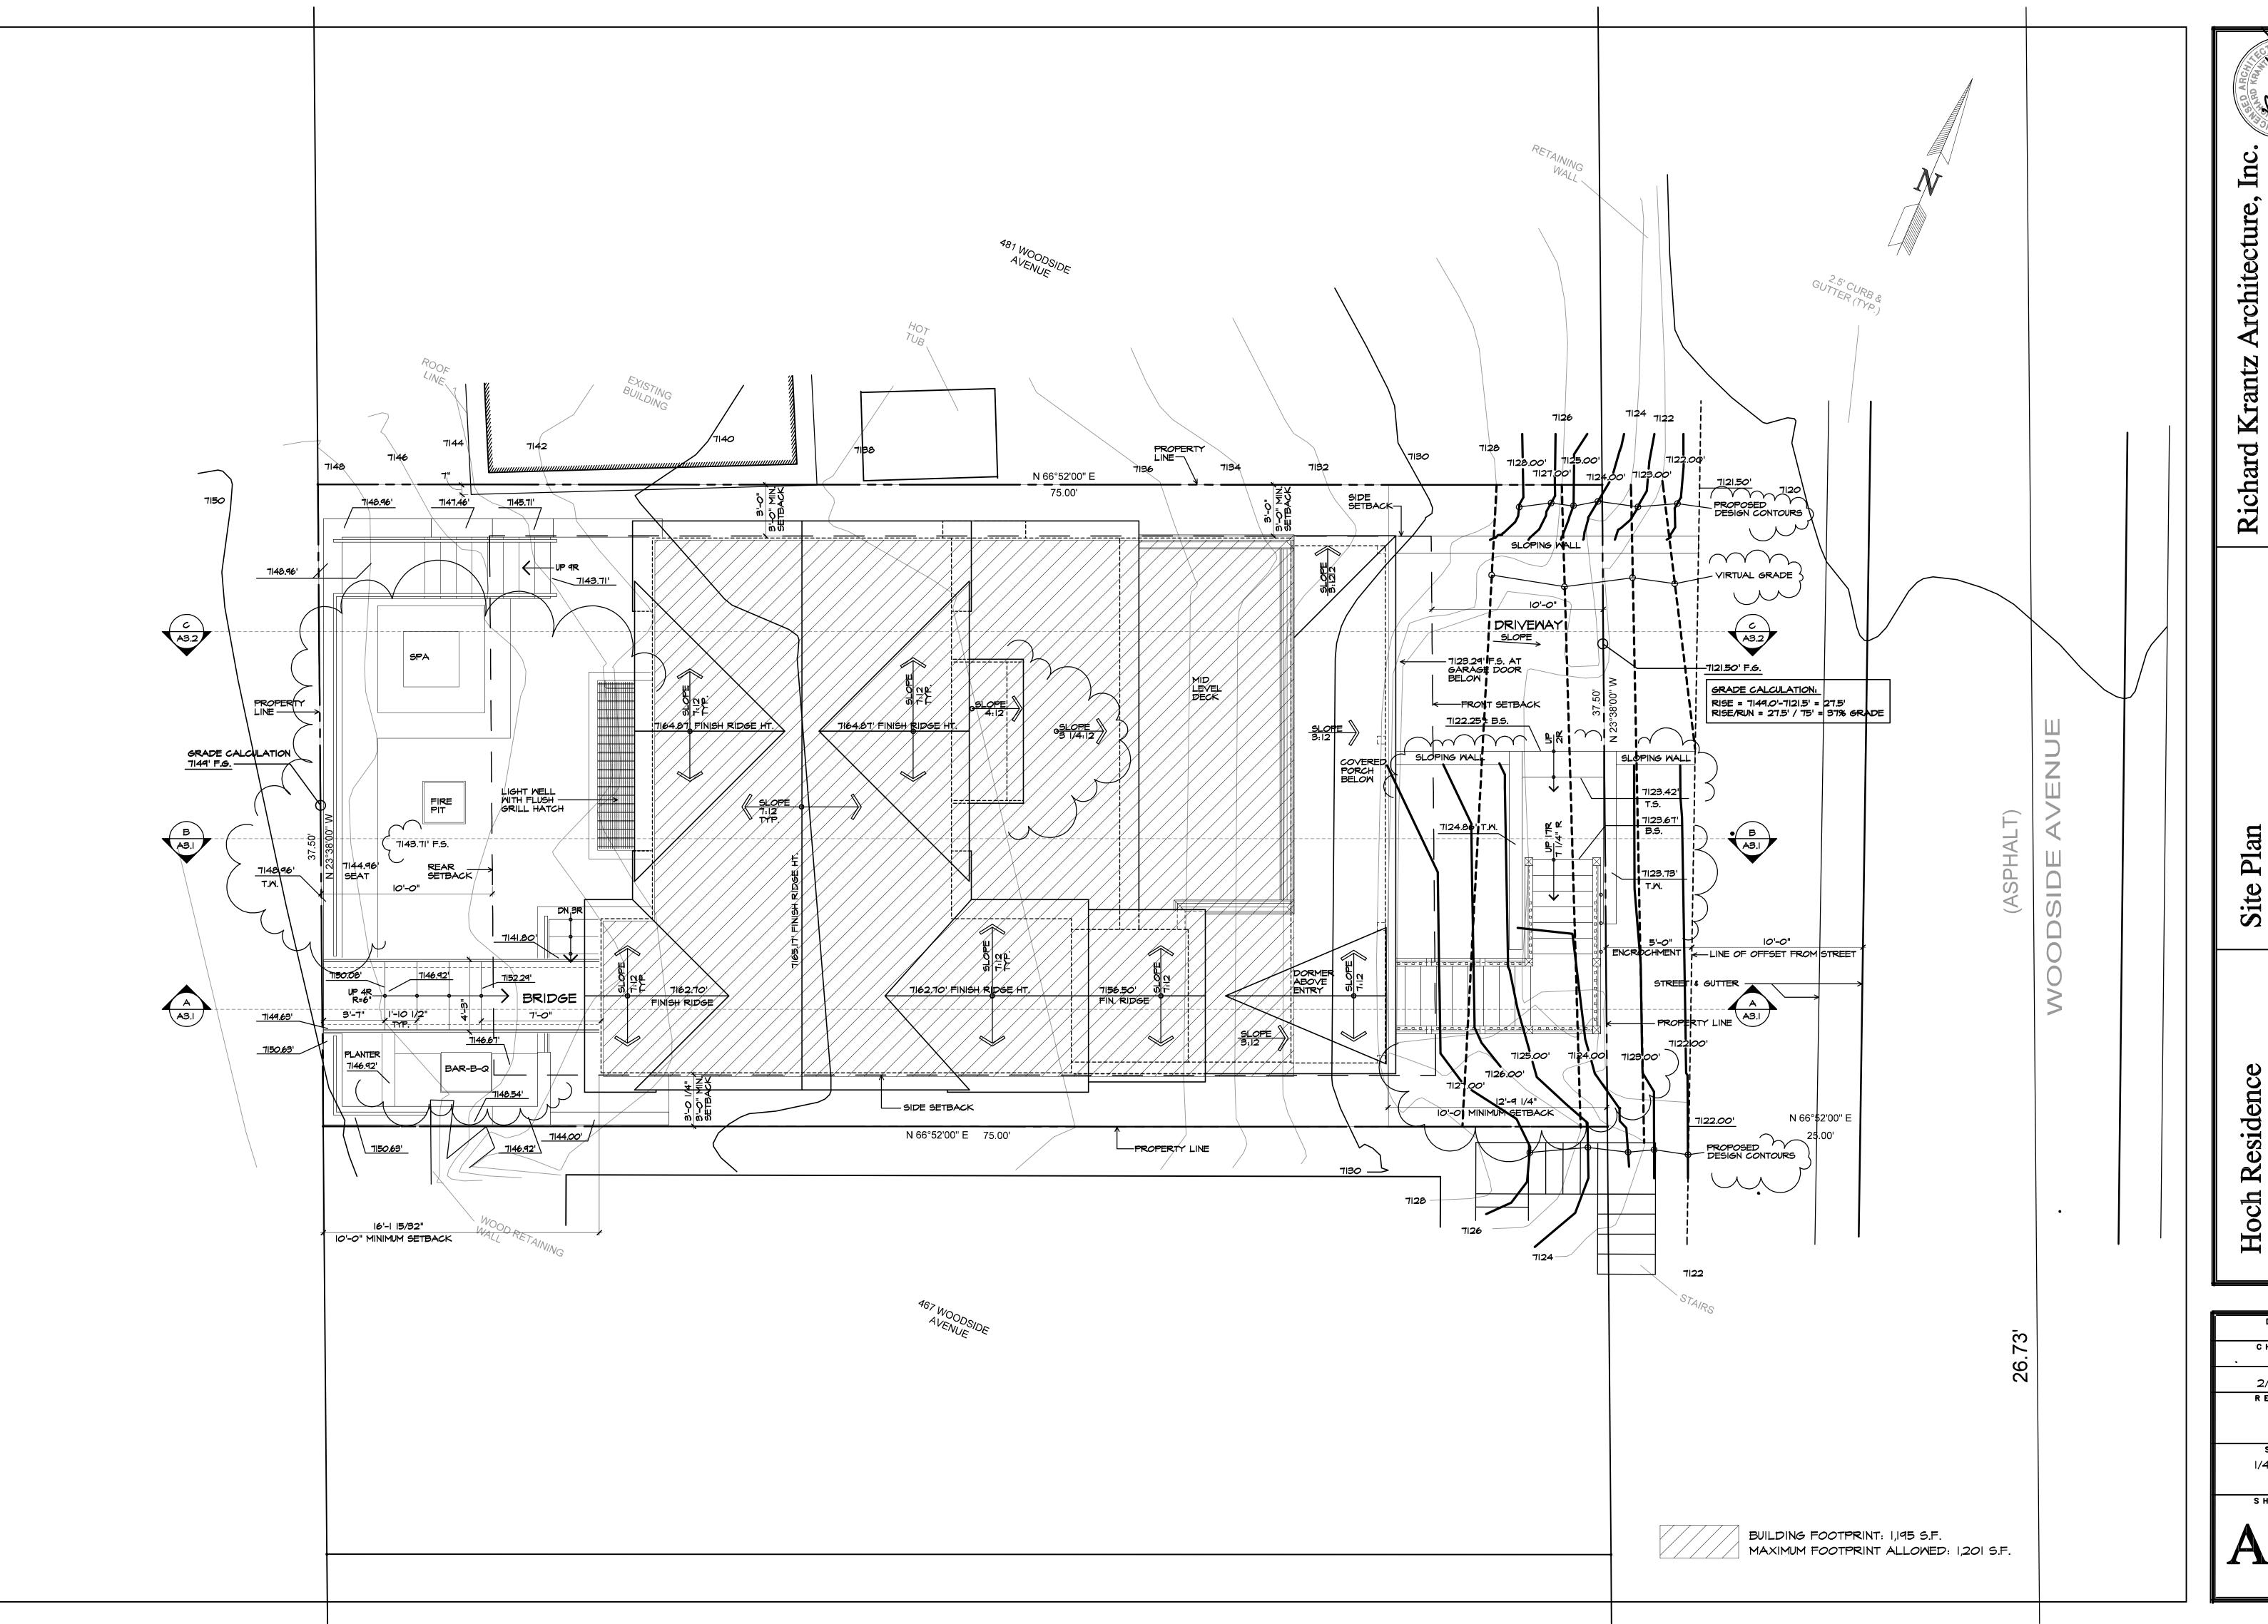

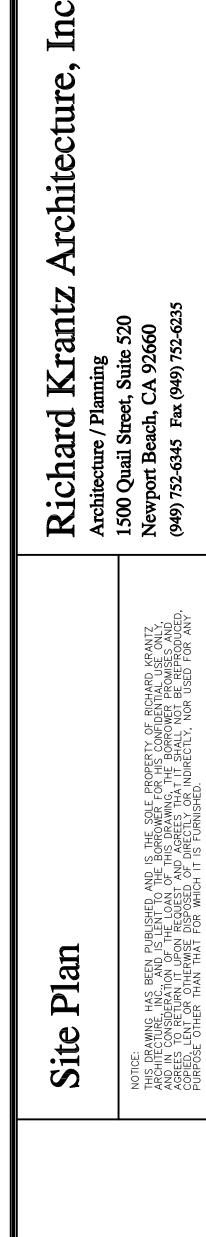

DRAWN AE
CHECKED R.K.
DATE 2/2/2023
REVISION
SCALE
/4" = '-0"
SHEET NO.

475 Woodside Avenue Park City, UT 84060

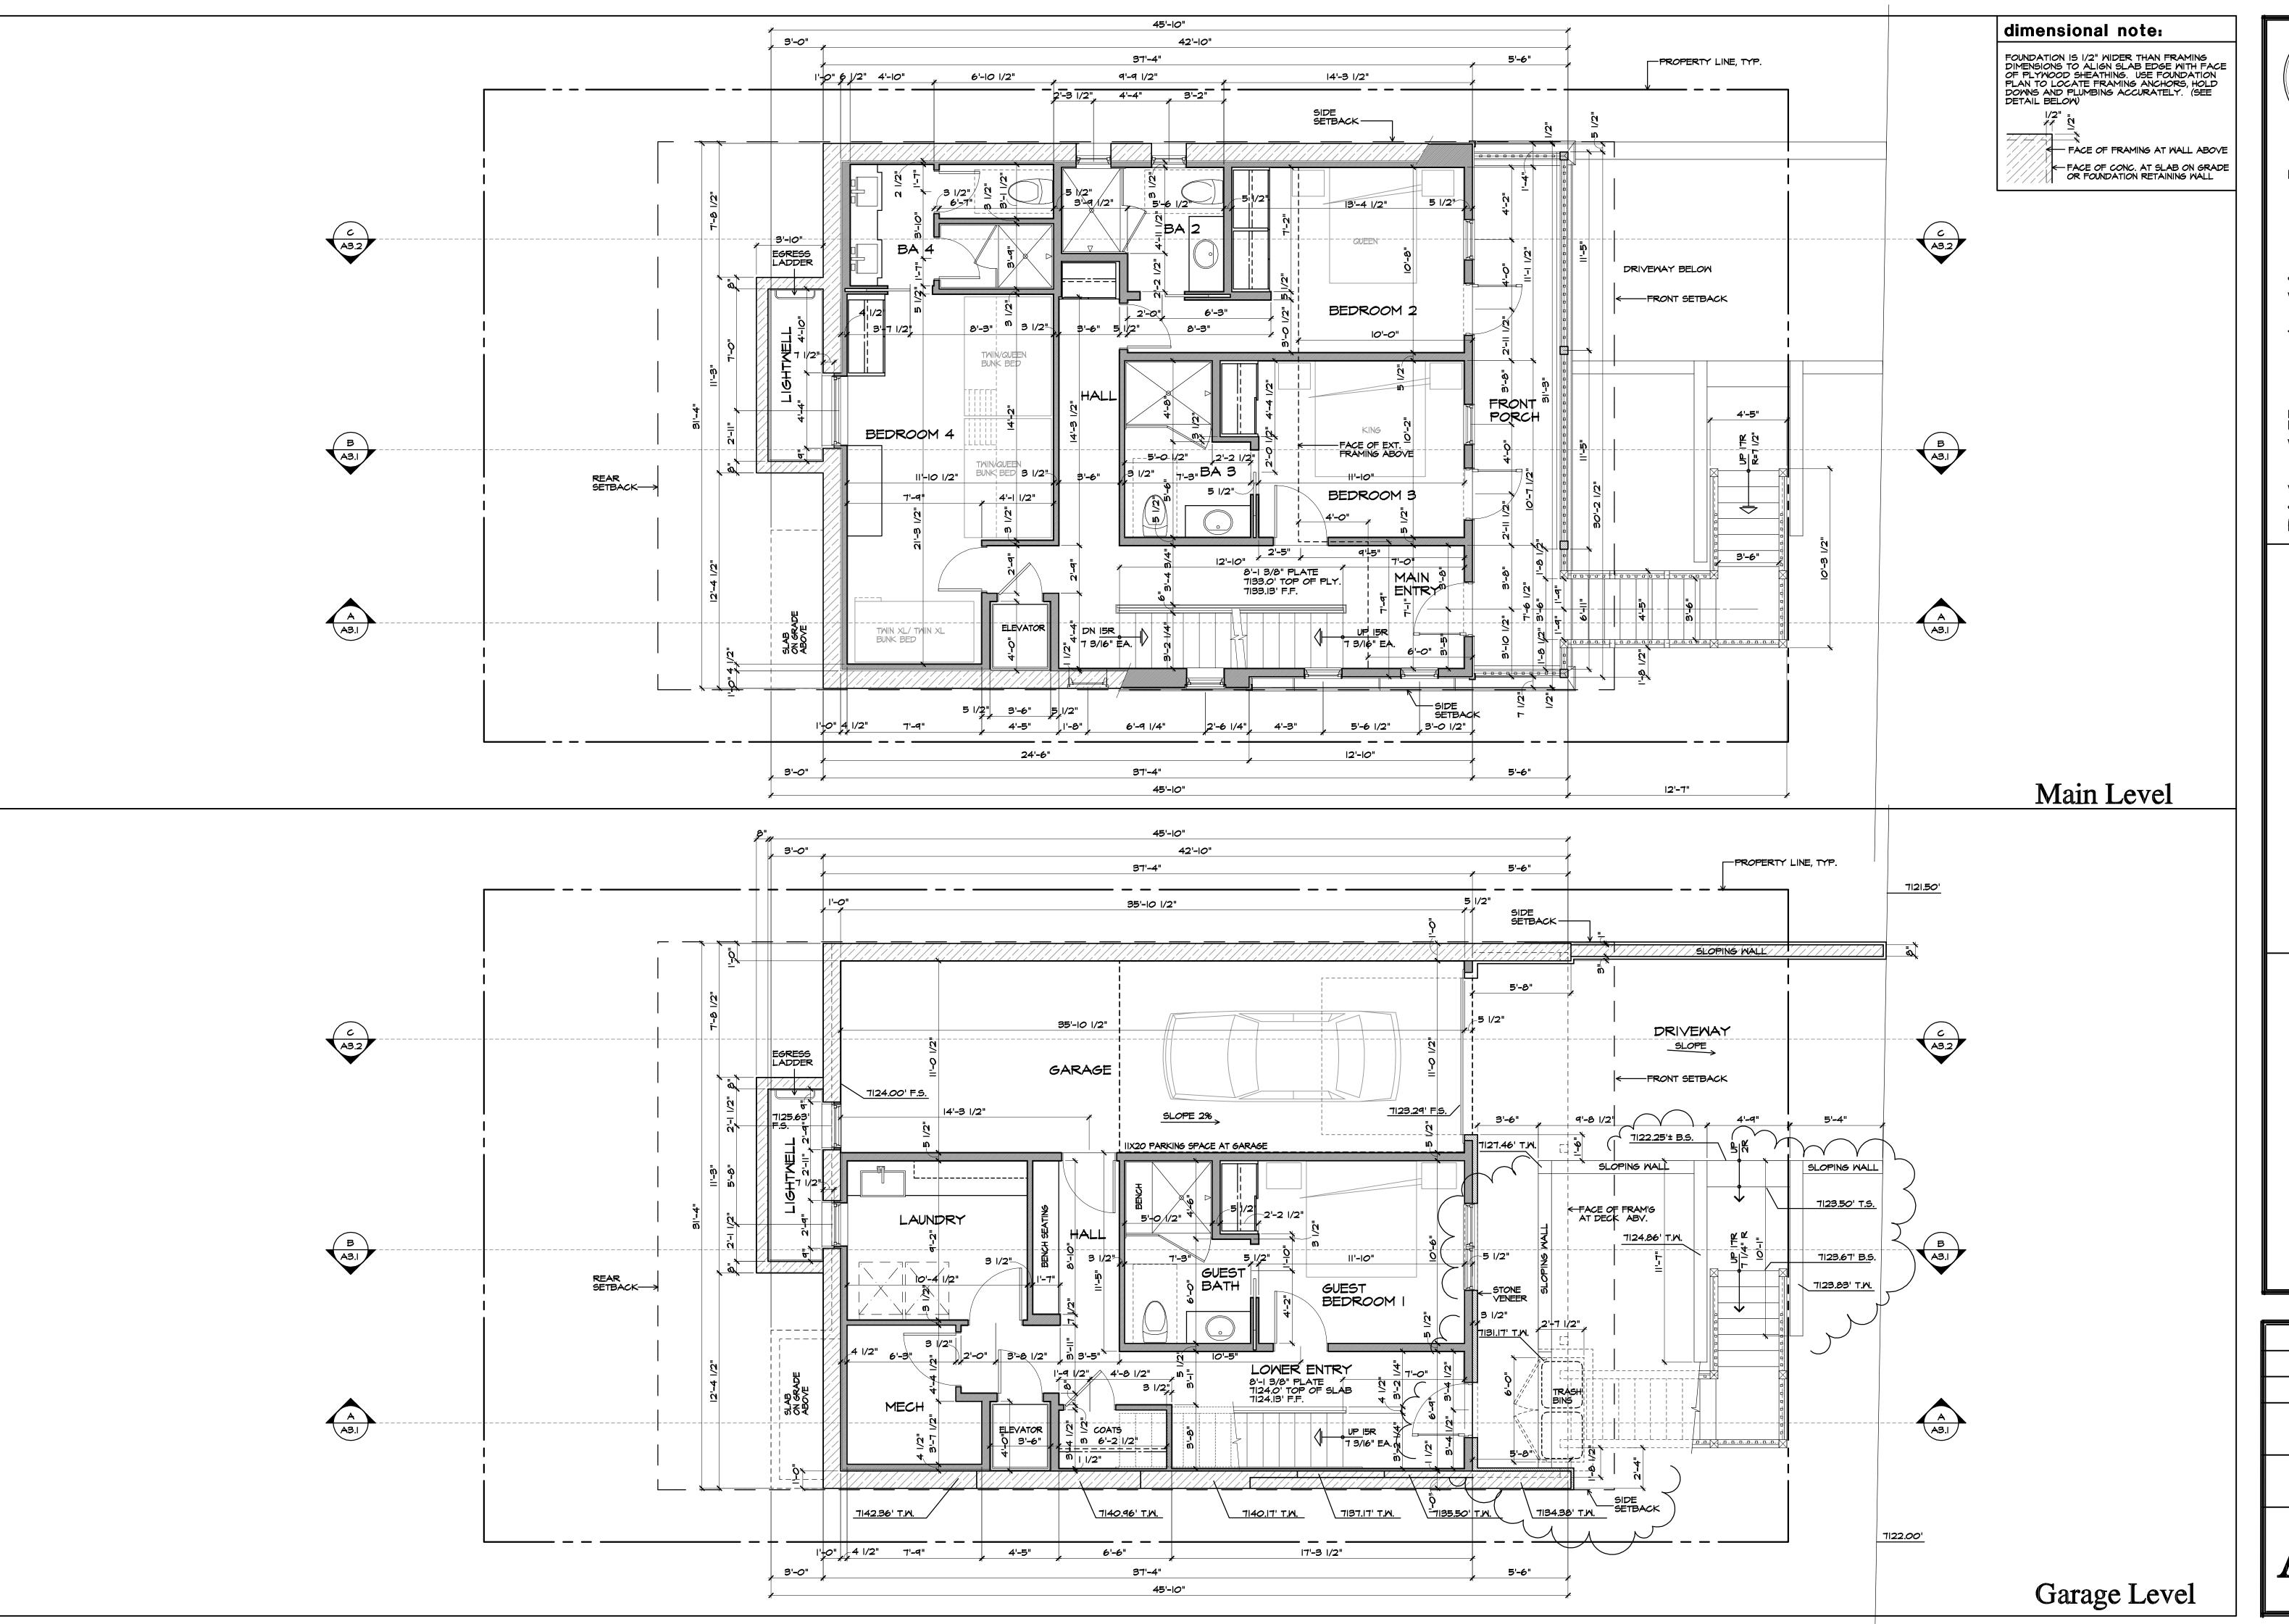

COUNTRION KRAINAND KR

Richard Krantz Architecture

Architecture / Planning
1500 Quail Street, Suite 520

Floor Plans (Garage and Mair

Hoch Residence 475 Woodside Avenue Park City, UT 84060

DRAWN
AE

CHECKED
R.K.


DATE
2/2/2023

REVISION

SCALE
1/4" = 1'-0"

SHEET NO.

⋣ 23

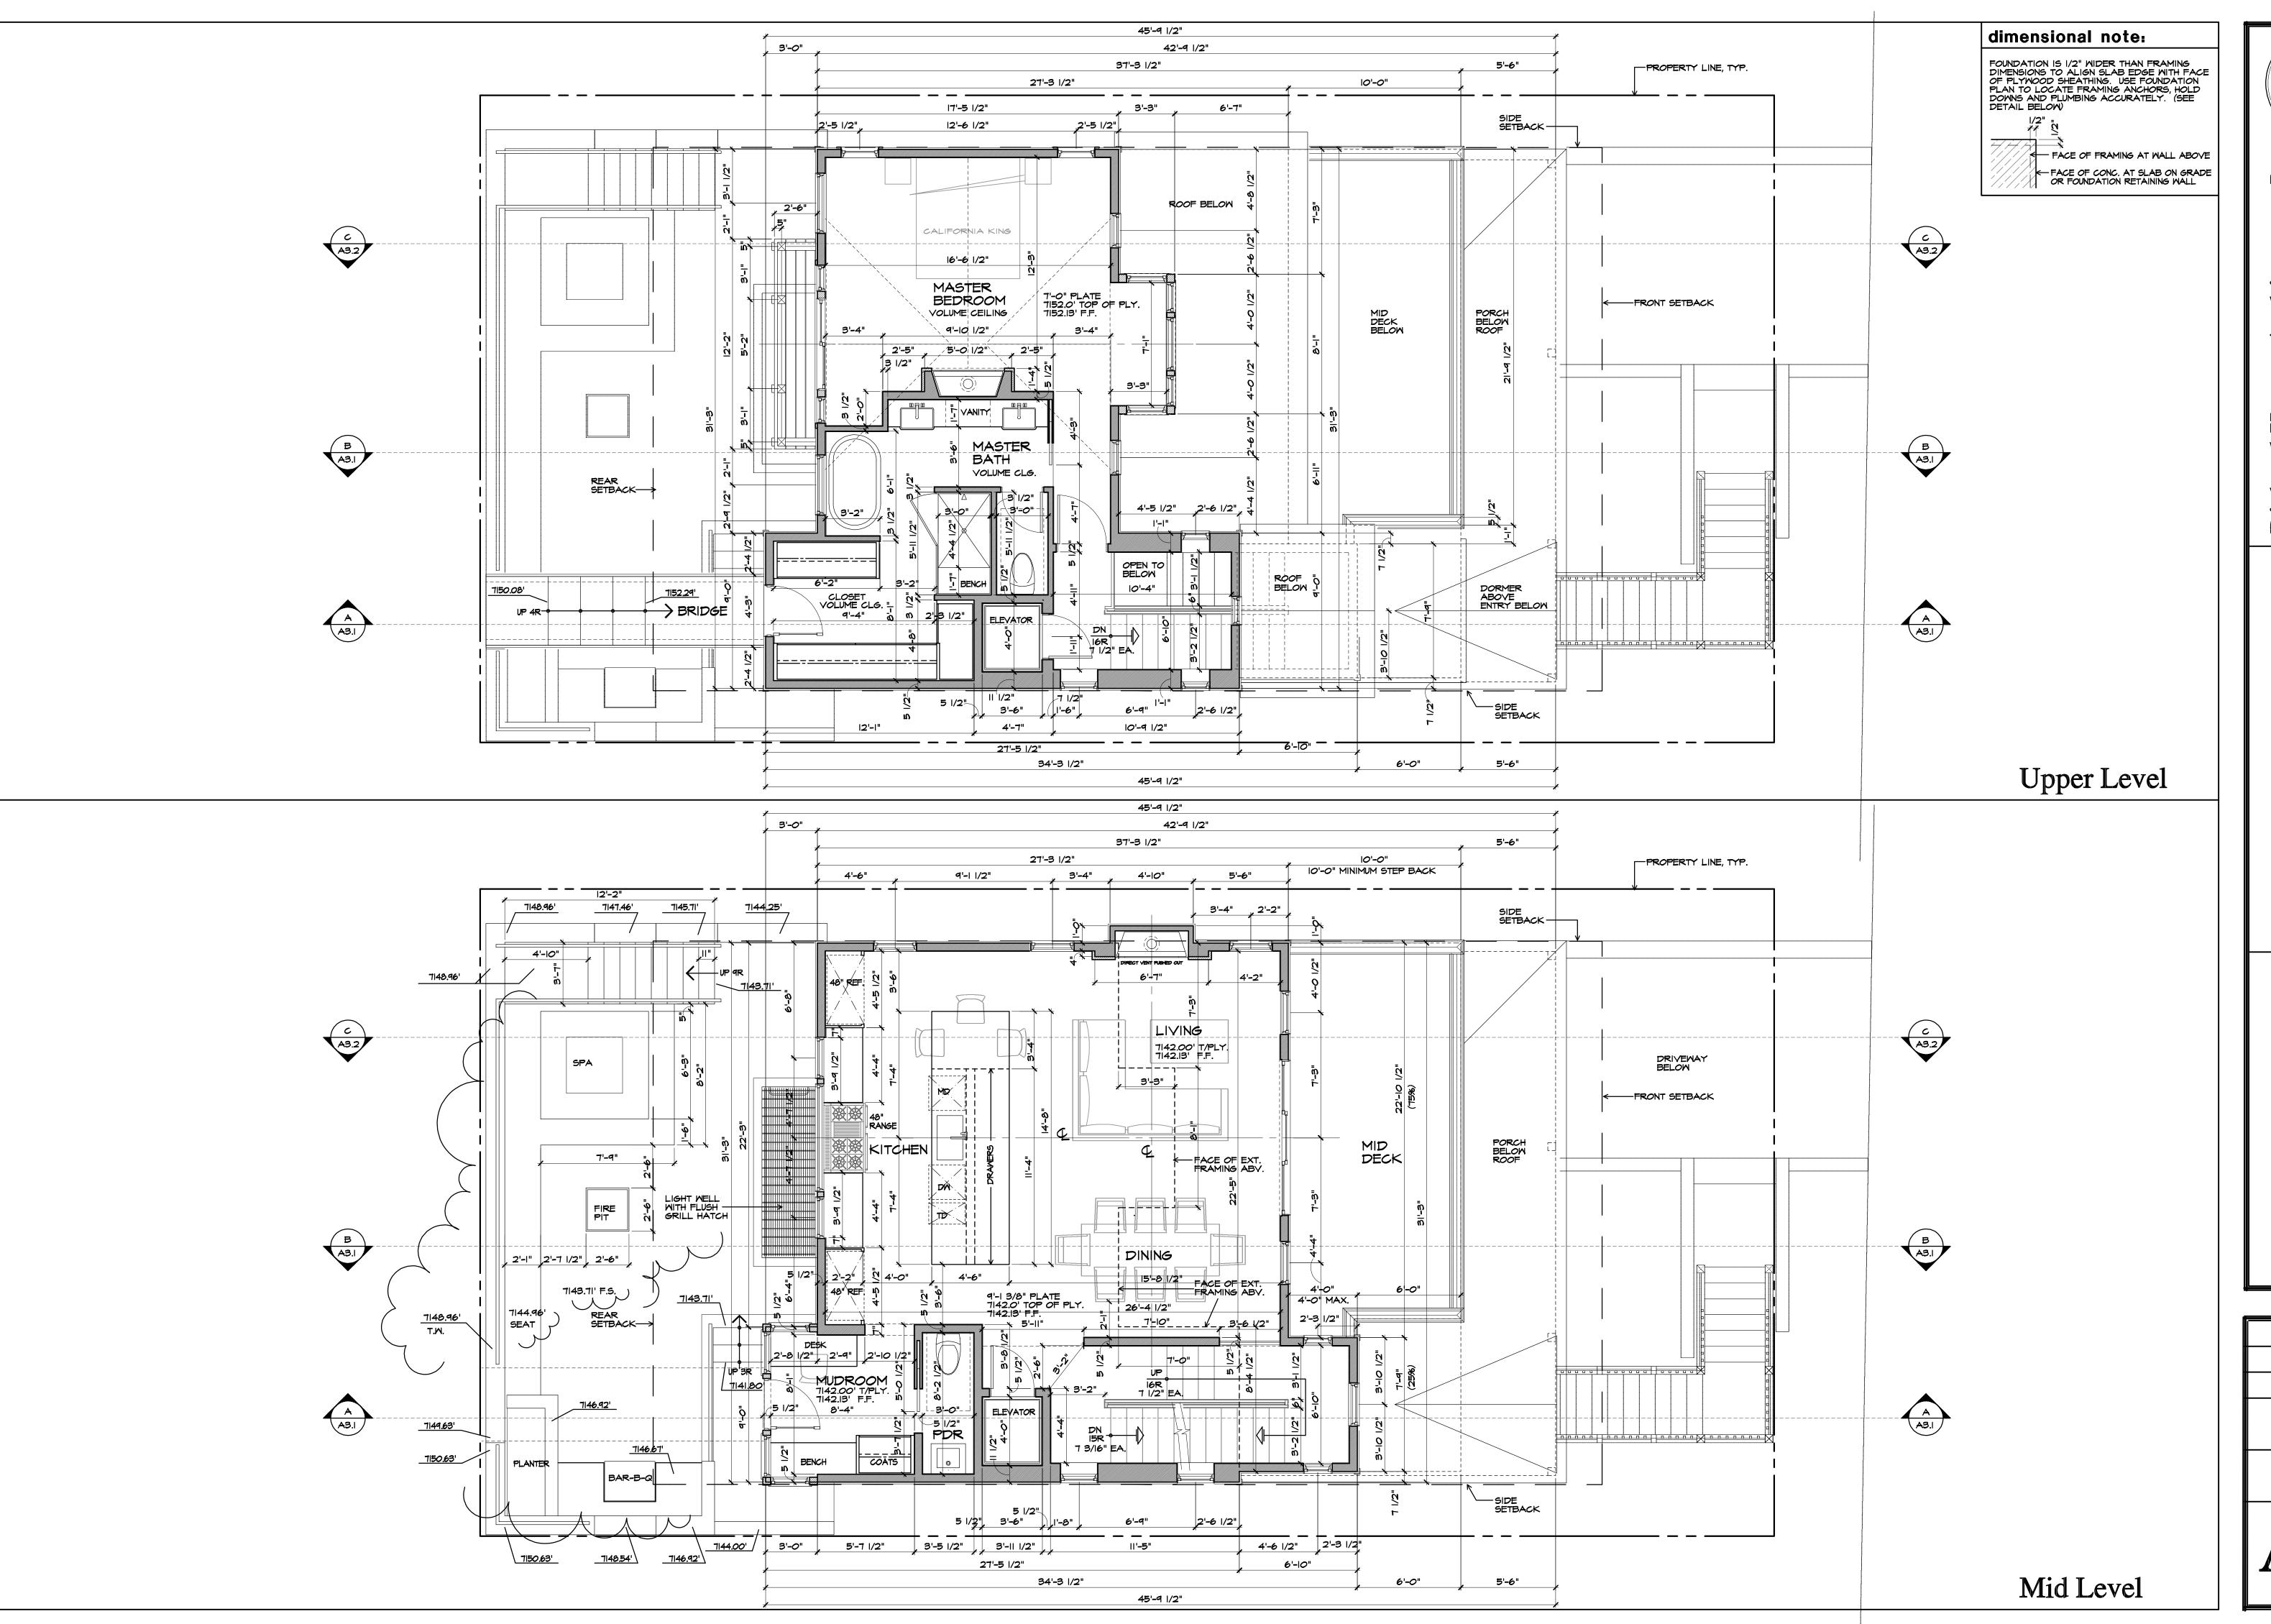

COUNTY OF OF UNIVERSITY OF UNI

Richard Krantz Architecture

Architecture / Planning
1500 Quail Street, Suite 520

Floor Plans (Mid and Upper)

Hoch Residence 475 Woodside Avenue Park City, UT 84060

DRAWN
AE


CHECKED
R.K.

DATE
2/2/2023

REVISION

SCALE
1/4" = 1'-0"


SHEET NO.

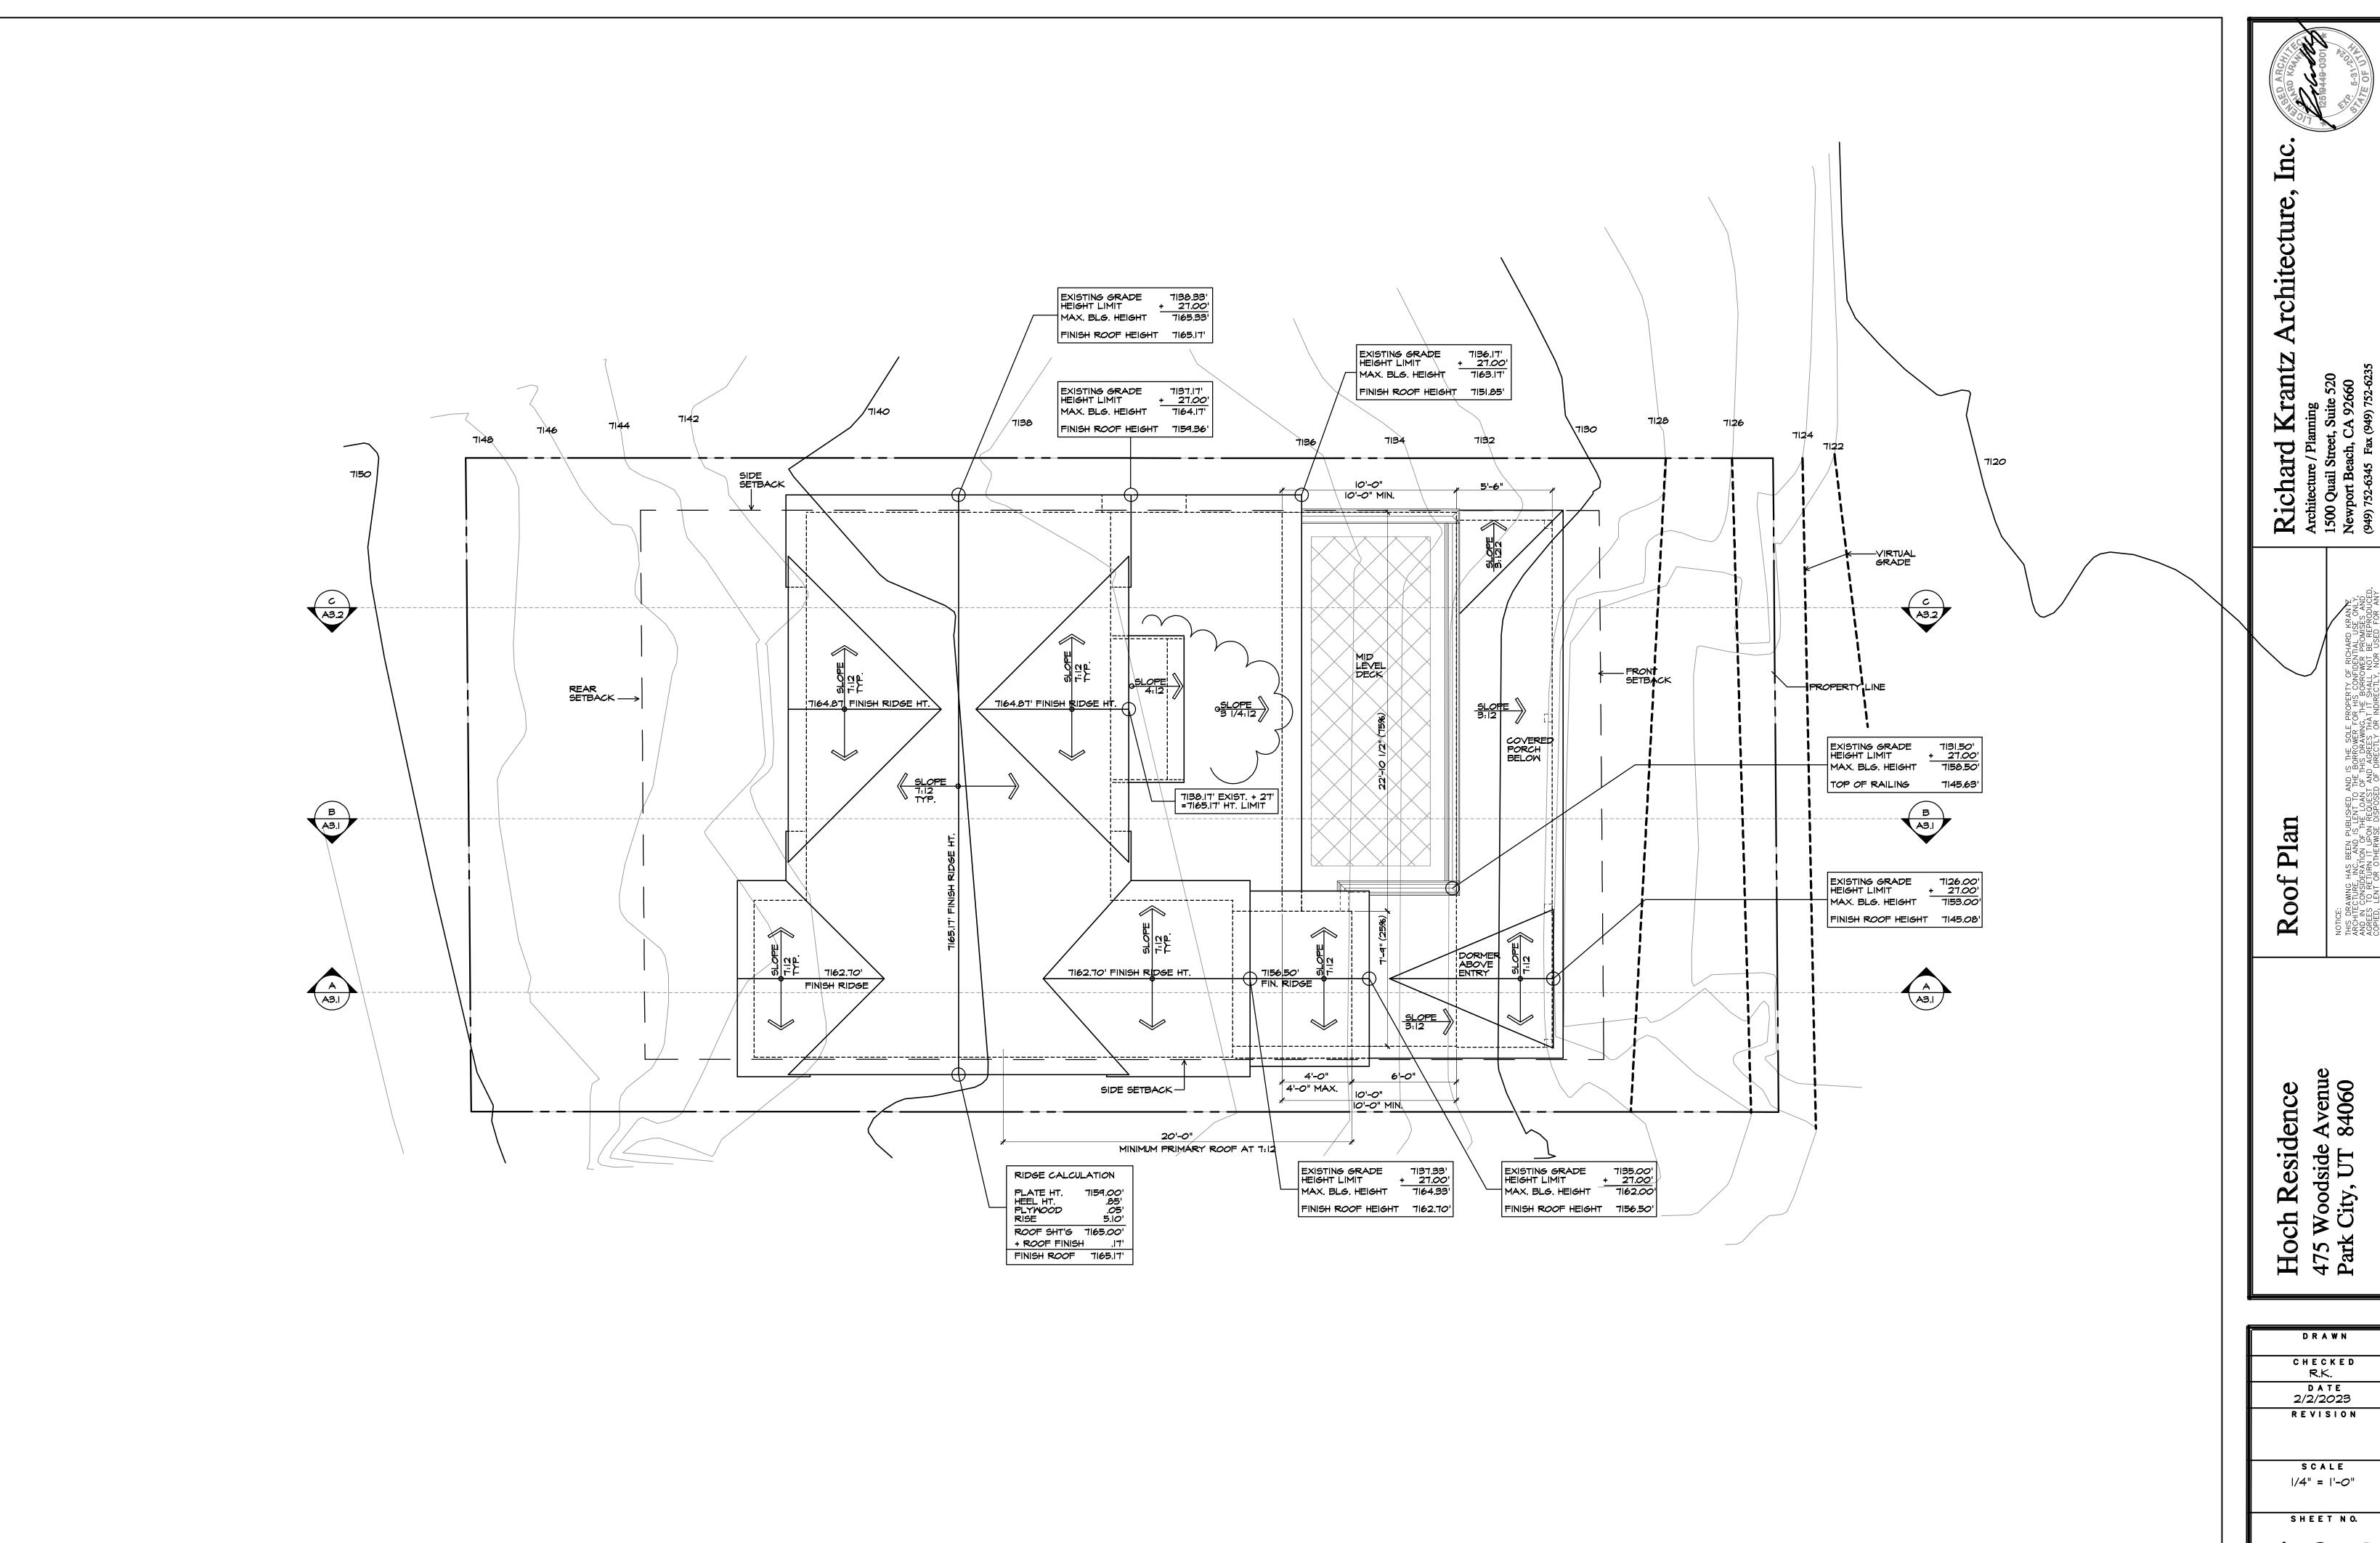


lan Roof P

Hoch Residence 475 Woodside Avenue Park City, UT 84060

DRAWN CHECKED R.K. D A T E 2/2/2023 REVISION SCALE 1/4" = 1'-0"

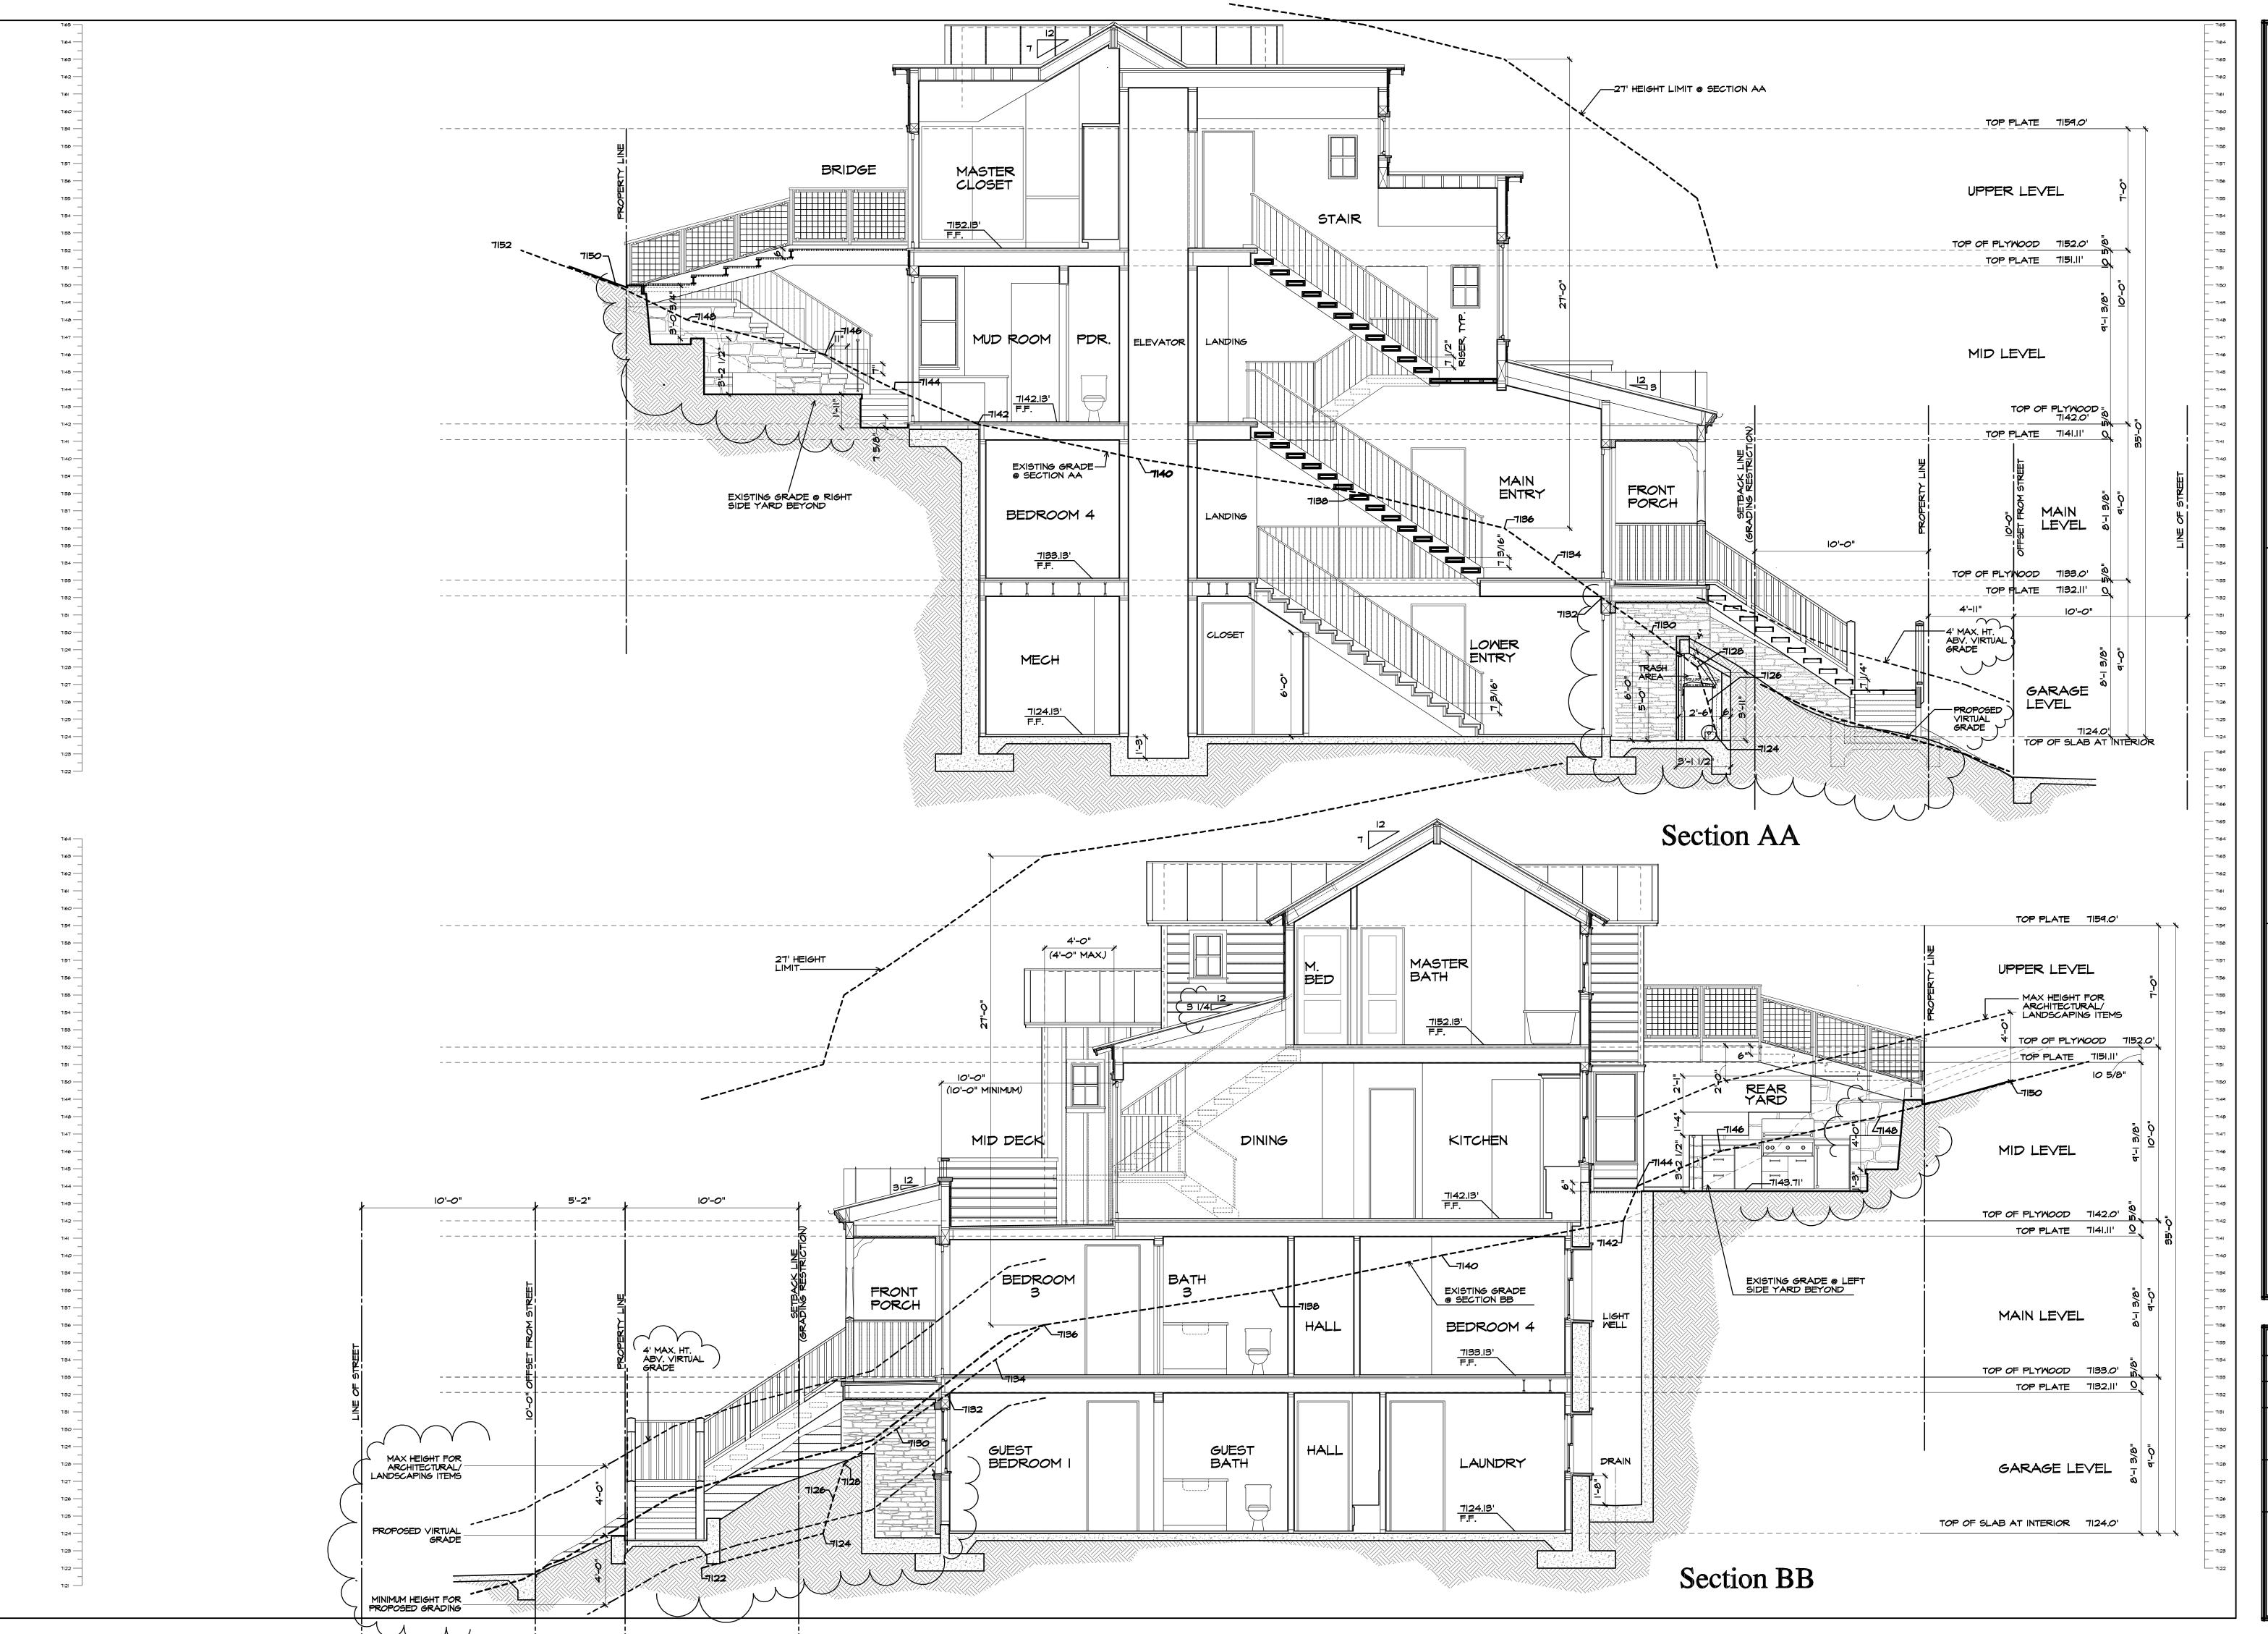

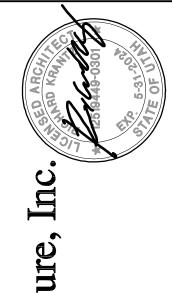

ure/Planning
il Street, Suite 520

Architecture / Planning
1500 Quail Street, Suite 52
AL USE ONLY, PROMISES AND
BE REPRODUCED, (949) 752-6345 Fax (949) 752-6


Residence bodside Avenue ty, UT 84060 THIS BEEN PUR ARCHITECTURE, INC., AND IS

Sections

DRAWN
AE
CHECKED
R.K.
DATE
2/2/2023
REVISION

SCALE
1/4" = 1'-0"

SHEET NO.

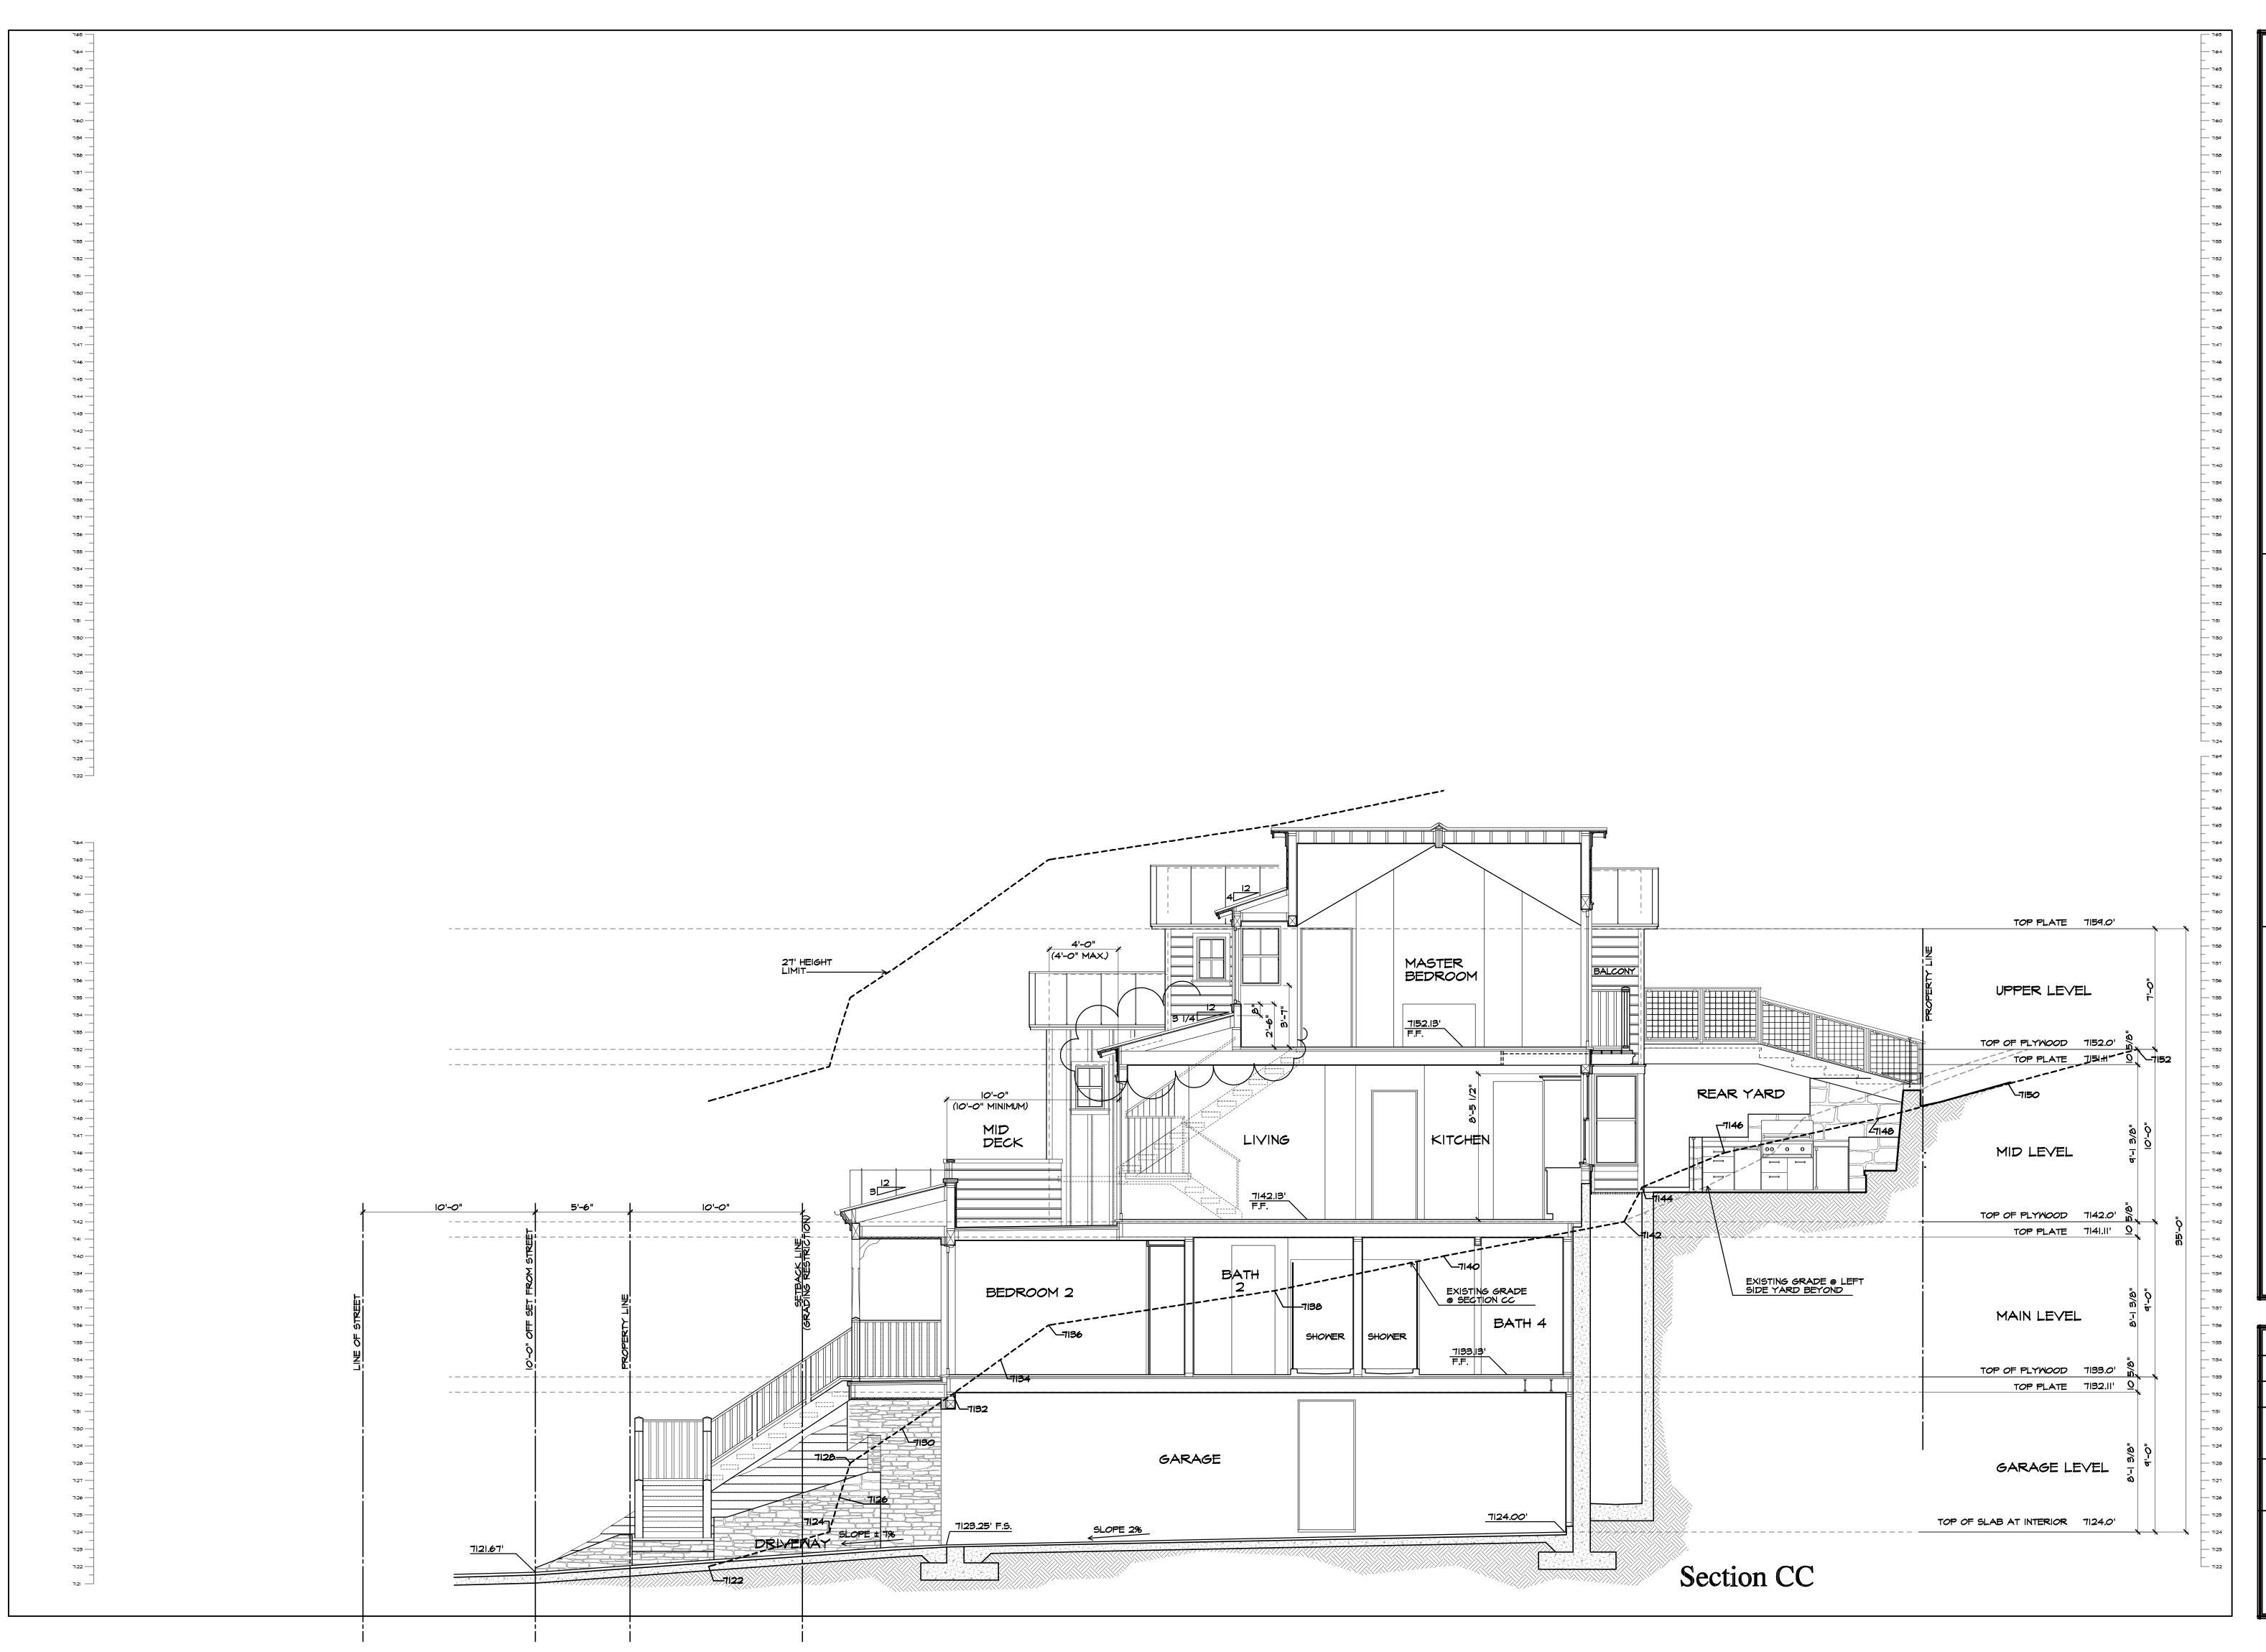



Richard Krantz Architecture / Planning

1500 Quail Street, Suite 520

Namort Beach, CA 92660


Building Sections

Hoch Residence 475 Woodside Avenue Park City, UT 84060

DRAWN
AE
CHECKED
R.K.
DATE
2/2/2023
REVISION

SCALE
1/4" = 1'-0"
SHEET NO.

43.2

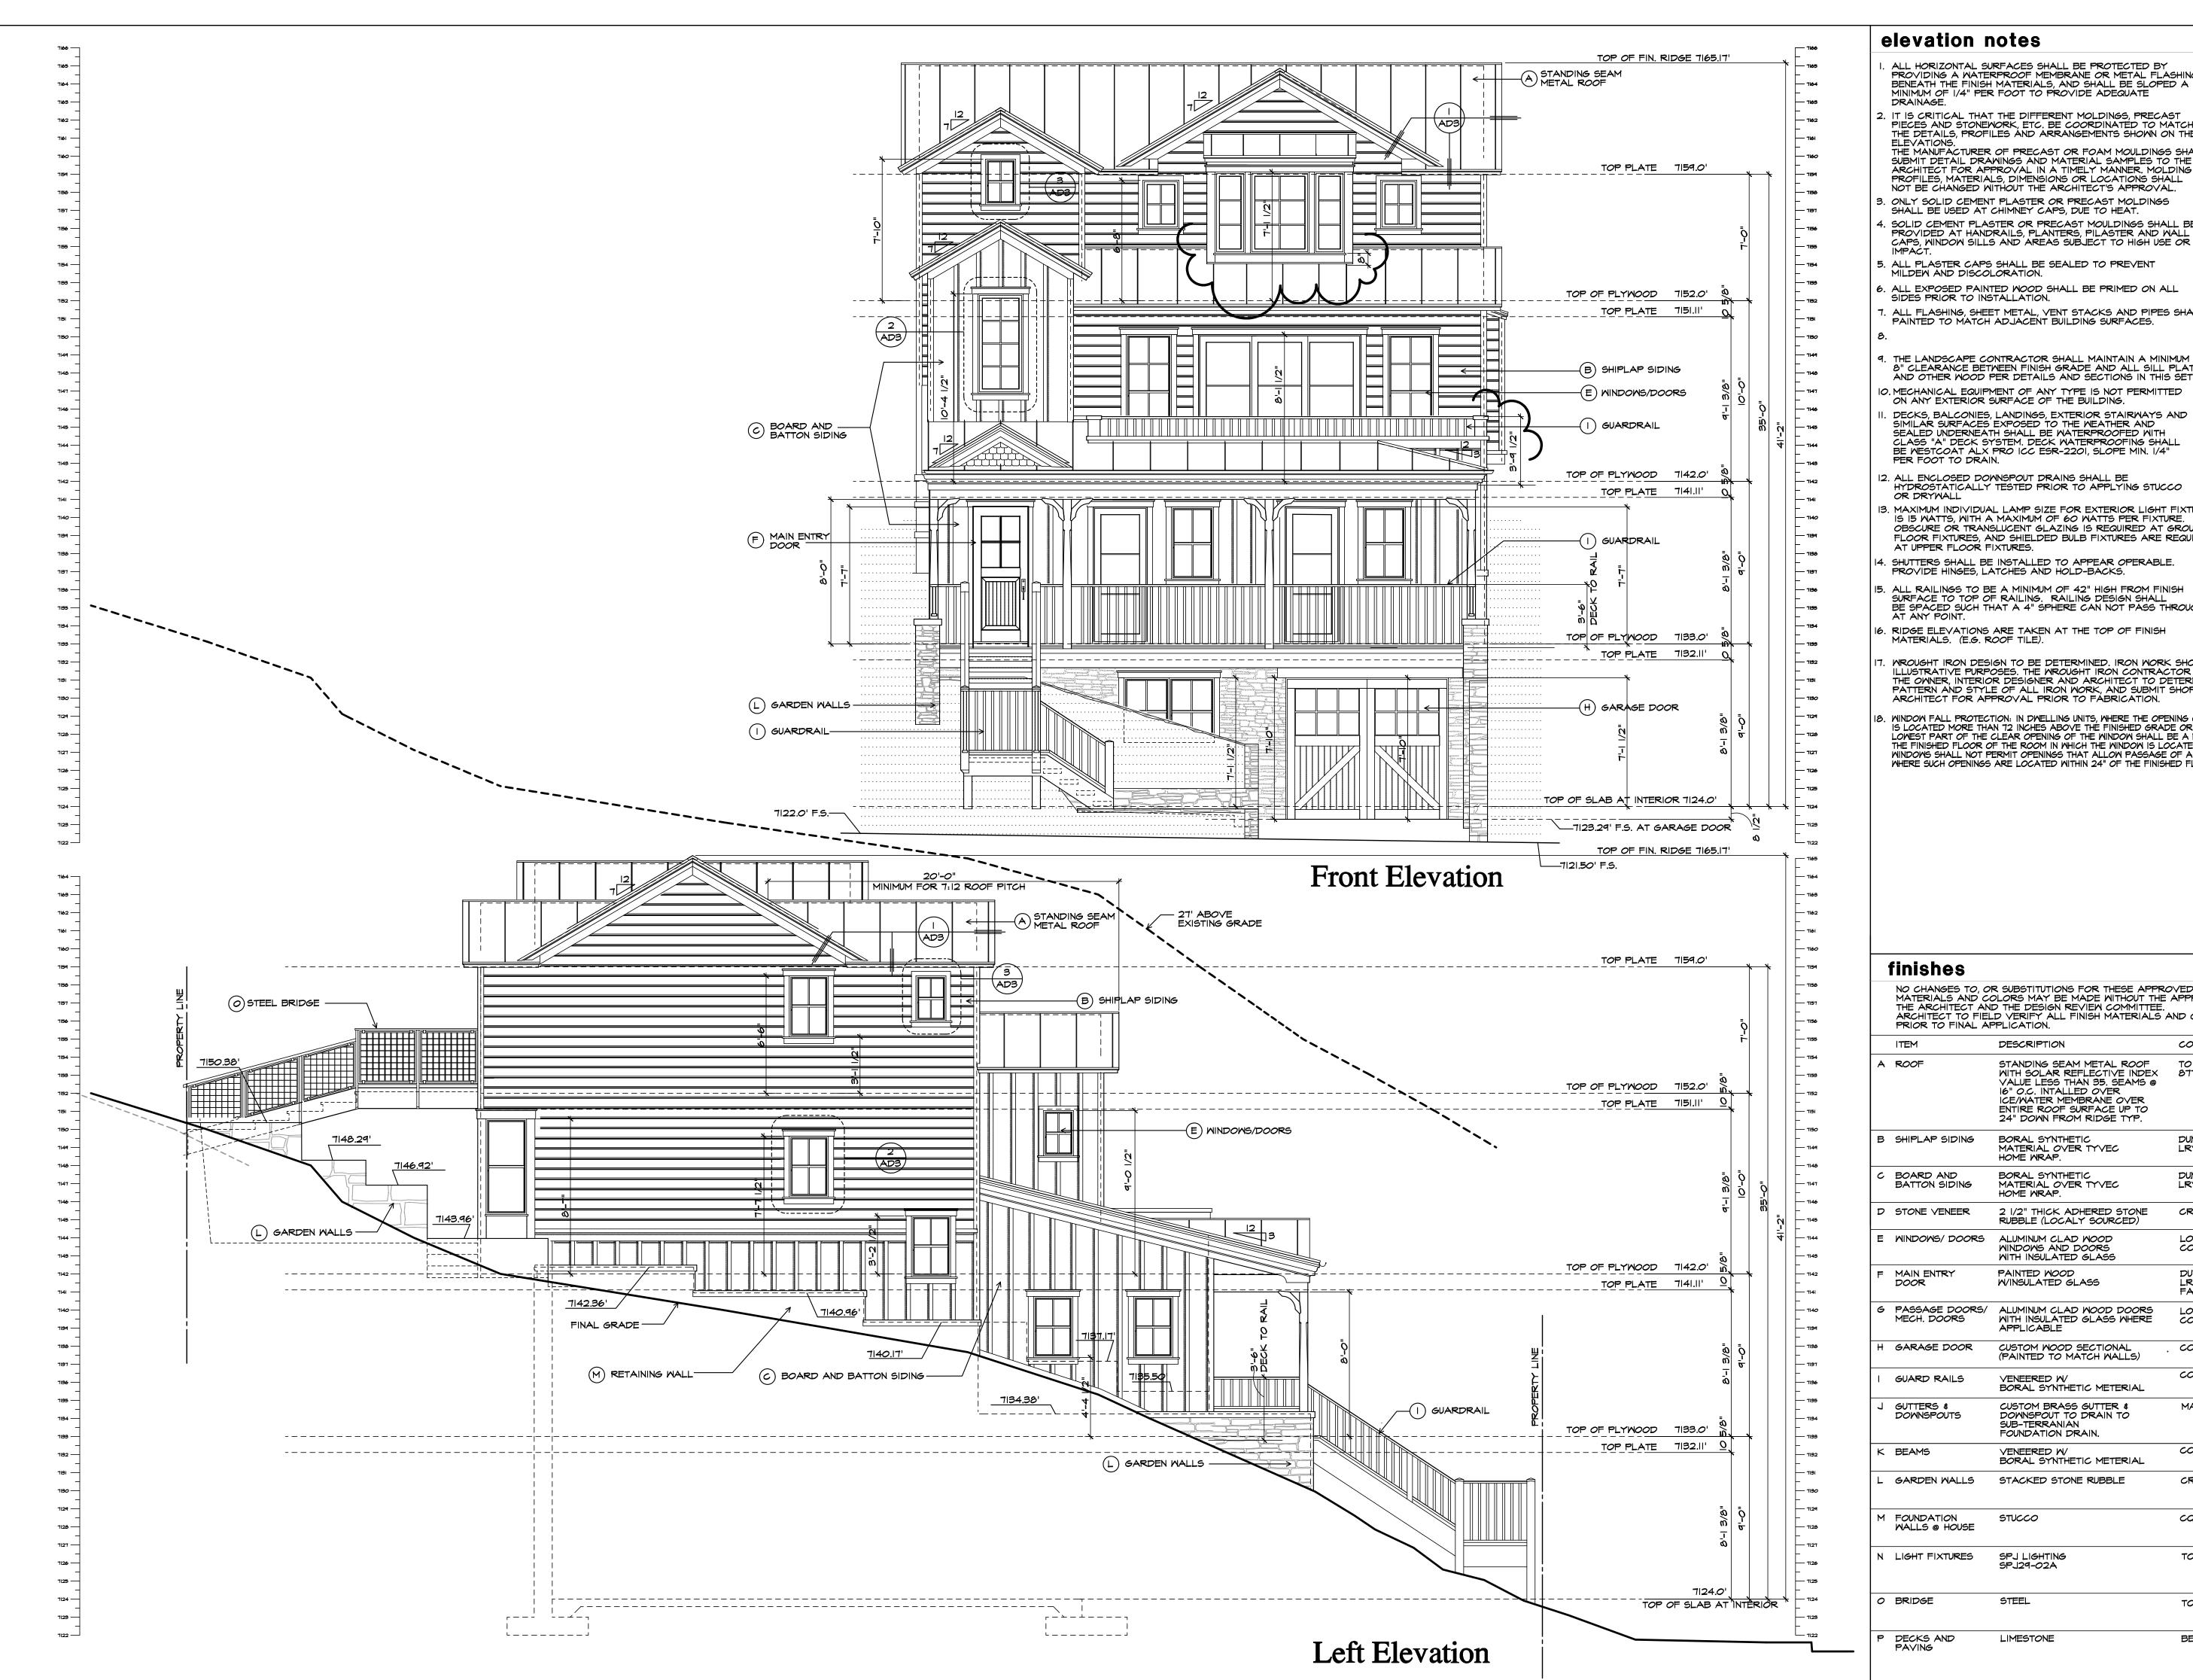

ALL HORIZONTAL SURFACES SHALL BE PROTECTED BY PROVIDING A WATERPROOF MEMBRANE OR METAL FLASHING BENEATH THE FINISH MATERIALS, AND SHALL BE SLOPED A MINIMUM OF 1/4" PER FOOT TO PROVIDE ADEQUATE

2. IT IS CRITICAL THAT THE DIFFERENT MOLDINGS, PRECAST PIECES AND STONEWORK, ETC. BE COORDINATED TO MATCH THE DETAILS, PROFILES AND ARRANGEMENTS SHOWN ON THE THE MANUFACTURER OF PRECAST OR FOAM MOULDINGS SHALL SUBMIT DETAIL DRAWINGS AND MATERIAL SAMPLES TO THE ARCHITECT FOR APPROVAL IN A TIMELY MANNER, MOLDING

. ONLY SOLID CEMENT PLASTER OR PRECAST MOLDINGS SHALL BE USED AT CHIMNEY CAPS, DUE TO HEAT.

SOLID CEMENT PLASTER OR PRECAST MOULDINGS SHALL BE PROVIDED AT HANDRAILS, PLANTERS, PILASTER AND WALL

6. ALL EXPOSED PAINTED WOOD SHALL BE PRIMED ON ALL SIDES PRIOR TO INSTALLATION.

. ALL FLASHING, SHEET METAL, VENT STACKS AND PIPES SHALL BE PAINTED TO MATCH ADJACENT BUILDING SURFACES.

. THE LANDSCAPE CONTRACTOR SHALL MAINTAIN A MINIMUM OF 8" CLEARANCE BETWEEN FINISH GRADE AND ALL SILL PLATES AND OTHER WOOD PER DETAILS AND SECTIONS IN THIS SET.

IO. MECHANICAL EQUIPMENT OF ANY TYPE IS NOT PERMITTED ON ANY EXTERIOR SURFACE OF THE BUILDING. DECKS, BALCONIES, LANDINGS, EXTERIOR STAIRWAYS AND SIMILAR SURFACES EXPOSED TO THE MEATHER AND

SEALED UNDERNEATH SHALL BE WATERPROOFED WITH CLASS "A" DECK SYSTEM. DECK WATERPROOFING SHALL BE WESTCOAT ALX PRO ICC ESR-2201, SLOPE MIN. 1/4"

12. ALL ENCLOSED DOWNSPOUT DRAINS SHALL BE HYDROSTATICALLY TESTED PRIOR TO APPLYING STUCCO

13. MAXIMUM INDIVIDUAL LAMP SIZE FOR EXTERIOR LIGHT FIXTURES IS 15 WATTS, WITH A MAXIMUM OF 60 WATTS PER FIXTURE. OBSCURE OR TRANSLUCENT GLAZING IS REQUIRED AT GROUND FLOOR FIXTURES, AND SHIELDED BULB FIXTURES ARE REQUIRED

SHUTTERS SHALL BE INSTALLED TO APPEAR OPERABLE. PROVIDE HINGES, LATCHES AND HOLD-BACKS.

5. ALL RAILINGS TO BE A MINIMUM OF 42" HIGH FROM FINISH SURFACE TO TOP OF RAILING. RAILING DESIGN SHALL BE SPACED SUCH THAT A 4" SPHERE CAN NOT PASS THROUGH

RIDGE ELEVATIONS ARE TAKEN AT THE TOP OF FINISH MATERIALS. (E.G. ROOF TILE).

MROUGHT IRON DESIGN TO BE DETERMINED. IRON WORK SHOWN HERE IS FOR ILLUSTRATIVE PURPOSES. THE WROUGHT IRON CONTRACTOR SHALL CONSULT WITH THE OWNER, INTERIOR DESIGNER AND ARCHITECT TO DETERMINE THE ACTUAL PATTERN AND STYLE OF ALL IRON WORK, AND SUBMIT SHOP DRAWINGS TO THE ARCHITECT FOR APPROVAL PRIOR TO FABRICATION.

WINDOW FALL PROTECTION: IN DWELLING UNITS, WHERE THE OPENING OF AN OPERABLE WINDOW IS LOCATED MORE THAN 72 INCHES ABOVE THE FINISHED GRADE OR SURFACE BELOW, THE LOWEST PART OF THE CLEAR OPENING OF THE WINDOW SHALL BE A MIN. OF 24 INCHES ABOVE THE FINISHED FLOOR OF THE ROOM IN WHICH THE WINDOW IS LOCATED. OPERABLE SECTIONS OF WINDOWS SHALL NOT PERMIT OPENINGS THAT ALLOW PASSAGE OF A 4" DIAMETER SPHERE WHERE SUCH OPENINGS ARE LOCATED WITHIN 24" OF THE FINISHED FLOOR. (CRC R312.2)

NO CHANGES TO, OR SUBSTITUTIONS FOR THESE APPROVED FINISH MATERIALS AND COLORS MAY BE MADE WITHOUT THE APPROVAL OF THE ARCHITECT AND THE DESIGN REVIEW COMMITTEE.
ARCHITECT TO FIELD VERIFY ALL FINISH MATERIALS AND COLORS PRIOR TO FINAL APPLICATION.

DESCRIPTION COLOR NAME TO MATCH FRAZEE: WITH SOLAR REFLECTIVE INDEX 8773M DAUPHIN GREY VALUE LESS THAN 35. SEAMS @ 16" O.C. INTALLED OVER ICE/WATER MEMBRANE OVER ENTIRE ROOF SURFACE UP TO 24" DOWN FROM RIDGE TYP. DUNN EDWARDS

BORAL SYNTHETIC MATERIAL OVER TYVEC LRV 87 DEM340 WHISPER HOME WRAP. DUNN EDWARDS MATERIAL OVER TYVEC LRY 87 DEW340 WHISPER HOME WRAP. 2 1/2" THICK ADHERED STONE RUBBLE (LOCALY SOURCED) CREAM/ TAN MINDOMS/ DOORS ALUMINUM CLAD MOOD WINDOMS AND DOORS WITH INSULATED GLASS COLOR TO MATCH SIDING DUNN EDWARDS LRV 80 DE5028 FAIRY WINGS PAINTED WOOD W/INSULATED GLASS PASSAGE DOORS/ ALUMINUM CLAD WOOD DOORS MECH. DOORS WITH INSULATED GLASS WHERE APPLICABLE

COLOR TO MATCH SIDING CUSTOM WOOD SECTIONAL (PAINTED TO MATCH WALLS) COLOR TO MATCH SIDING COLOR TO MATCH SIDING VENEERED W/ BORAL SYNTHETIC METERIAL CUSTOM BRASS GUTTER & DOWNSPOUT TO DRAIN TO SUB-TERRANIAN MATCH ROOF COLOR FOUNDATION DRAIN. COLOR TO MATCH SIDING VENEERED W/ BORAL SYNTHETIC METERIAL

STACKED STONE RUBBLE CREAM/ TAN

COLOR TO MATCH SIDING SPJ LIGHTING SPJ29-02A TO MATCH ROOF

TO MATCH ROOF BEIGE

1/4" = 1'-0" SHEET NO.

DRAWN

CHECKED

DATE

REVISION

SCALE

R.K.

2/3/2023

Avenue 84060


sid

ch

ation

E

Or

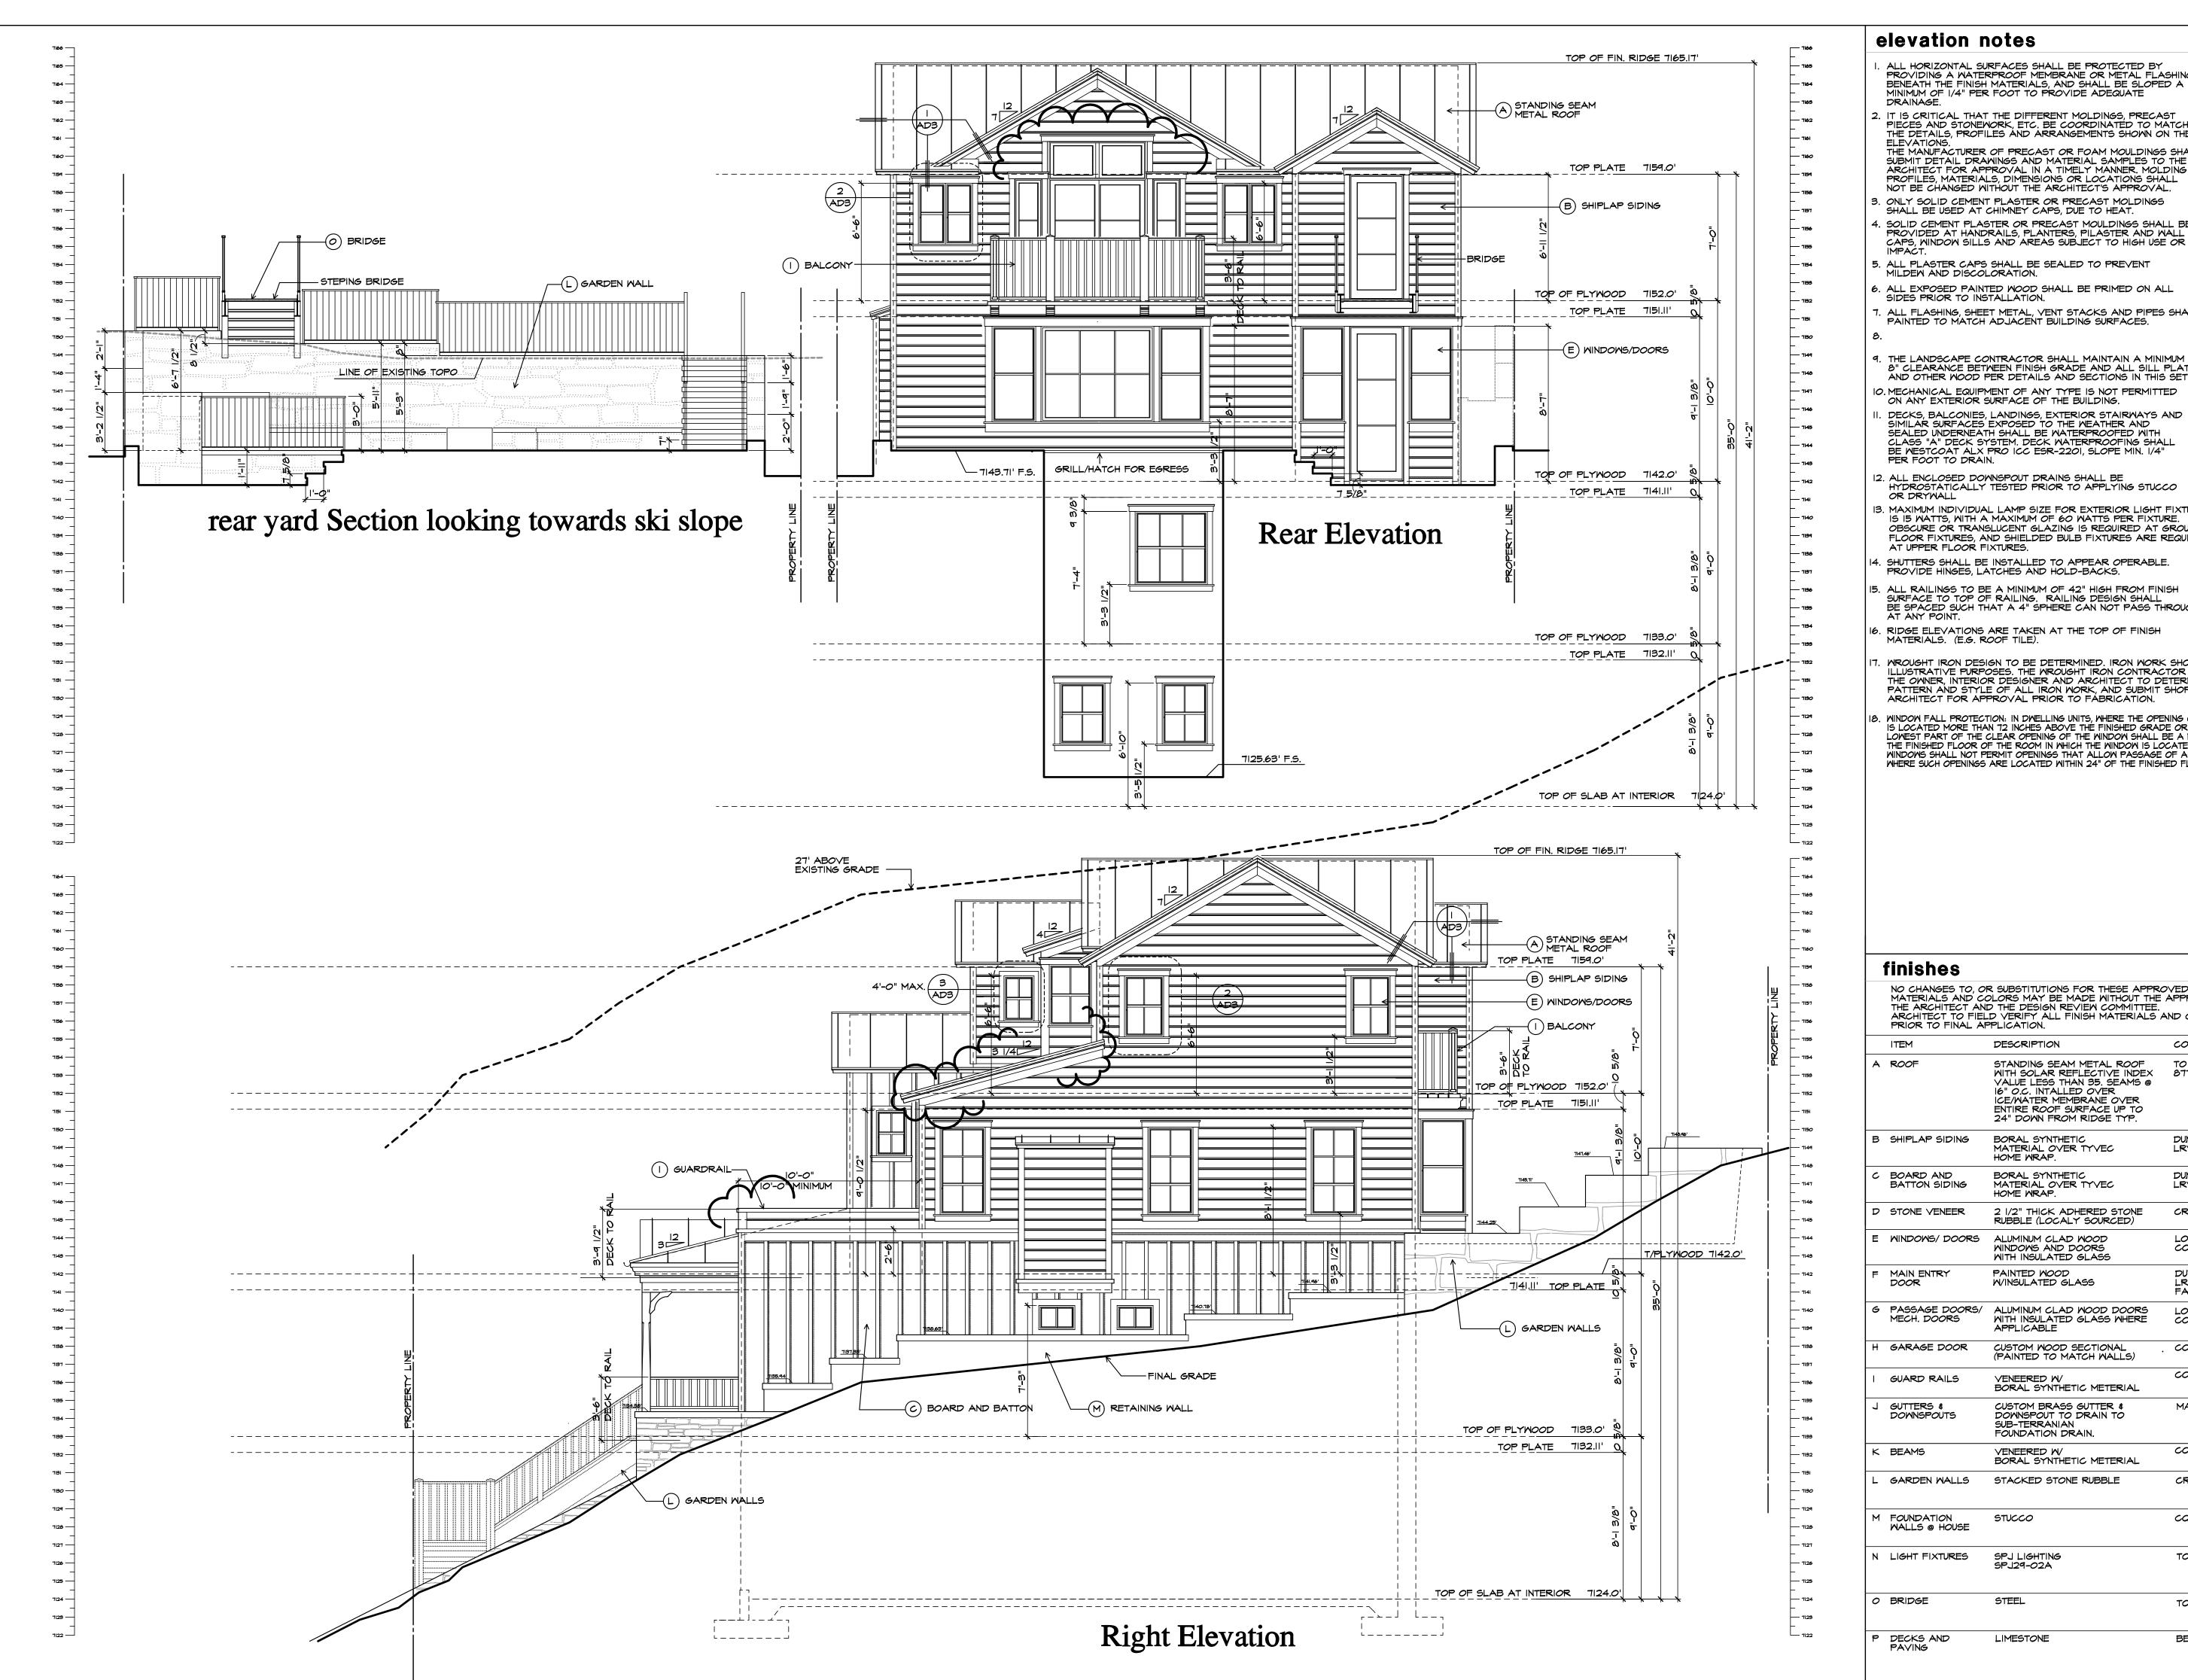

elevation notes

ALL HORIZONTAL SURFACES SHALL BE PROTECTED BY PROVIDING A WATERPROOF MEMBRANE OR METAL FLASHING BENEATH THE FINISH MATERIALS, AND SHALL BE SLOPED A MINIMUM OF 1/4" PER FOOT TO PROVIDE ADEQUATE

2. IT IS CRITICAL THAT THE DIFFERENT MOLDINGS, PRECAST PIECES AND STONEWORK, ETC. BE COORDINATED TO MATCH THE DETAILS, PROFILES AND ARRANGEMENTS SHOWN ON THE ELEVATIONS. THE MANUFACTURER OF PRECAST OR FOAM MOULDINGS SHALL SUBMIT DETAIL DRAWINGS AND MATERIAL SAMPLES TO THE ARCHITECT FOR APPROVAL IN A TIMELY MANNER. MOLDING

ONLY SOLID CEMENT PLASTER OR PRECAST MOLDINGS SHALL BE USED AT CHIMNEY CAPS, DUE TO HEAT.

. SOLID CEMENT PLASTER OR PRECAST MOULDINGS SHALL BE PROVIDED AT HANDRAILS, PLANTERS, PILASTER AND WALL

5. ALL PLASTER CAPS SHALL BE SEALED TO PREVENT MILDEM AND DISCOLORATION.

6. ALL EXPOSED PAINTED WOOD SHALL BE PRIMED ON ALL SIDES PRIOR TO INSTALLATION.

. ALL FLASHING, SHEET METAL, VENT STACKS AND PIPES SHALL BE PAINTED TO MATCH ADJACENT BUILDING SURFACES.

7. THE LANDSCAPE CONTRACTOR SHALL MAINTAIN A MINIMUM OF 8" CLEARANCE BETWEEN FINISH GRADE AND ALL SILL PLATES AND OTHER WOOD PER DETAILS AND SECTIONS IN THIS SET.

IO. MECHANICAL EQUIPMENT OF ANY TYPE IS NOT PERMITTED ON ANY EXTERIOR SURFACE OF THE BUILDING. DECKS, BALCONIES, LANDINGS, EXTERIOR STAIRWAYS AND SIMILAR SURFACES EXPOSED TO THE MEATHER AND SEALED UNDERNEATH SHALL BE WATERPROOFED WITH CLASS "A" DECK SYSTEM. DECK WATERPROOFING SHALL

12. ALL ENCLOSED DOWNSPOUT DRAINS SHALL BE HYDROSTATICALLY TESTED PRIOR TO APPLYING STUCCO

13. MAXIMUM INDIVIDUAL LAMP SIZE FOR EXTERIOR LIGHT FIXTURES IS 15 WATTS, WITH A MAXIMUM OF 60 WATTS PER FIXTURE. OBSCURE OR TRANSLUCENT GLAZING IS REQUIRED AT GROUND FLOOR FIXTURES, AND SHIELDED BULB FIXTURES ARE REQUIRED AT UPPER FLOOR FIXTURES.

SHUTTERS SHALL BE INSTALLED TO APPEAR OPERABLE. PROVIDE HINGES, LATCHES AND HOLD-BACKS.

5. ALL RAILINGS TO BE A MINIMUM OF 42" HIGH FROM FINISH SURFACE TO TOP OF RAILING. RAILING DESIGN SHALL BE SPACED SUCH THAT A 4" SPHERE CAN NOT PASS THROUGH

RIDGE ELEVATIONS ARE TAKEN AT THE TOP OF FINISH MATERIALS. (E.G. ROOF TILE).

. WROUGHT IRON DESIGN TO BE DETERMINED. IRON WORK SHOWN HERE IS FOR ILLUSTRATIVE PURPOSES. THE WROUGHT IRON CONTRACTOR SHALL CONSULT WITH THE OWNER, INTERIOR DESIGNER AND ARCHITECT TO DETERMINE THE ACTUAL PATTERN AND STYLE OF ALL IRON WORK, AND SUBMIT SHOP DRAWINGS TO THE ARCHITECT FOR APPROVAL PRIOR TO FABRICATION.

WINDOW FALL PROTECTION: IN DWELLING UNITS, WHERE THE OPENING OF AN OPERABLE WINDOW IS LOCATED MORE THAN 72 INCHES ABOVE THE FINISHED GRADE OR SURFACE BELOW, THE LOWEST PART OF THE CLEAR OPENING OF THE WINDOW SHALL BE A MIN. OF 24 INCHES ABOVE THE FINISHED FLOOR OF THE ROOM IN WHICH THE WINDOW IS LOCATED. OPERABLE SECTIONS OF WINDOWS SHALL NOT PERMIT OPENINGS THAT ALLOW PASSAGE OF A 4" DIAMETER SPHERE WHERE SUCH OPENINGS ARE LOCATED WITHIN 24" OF THE FINISHED FLOOR. (CRC R312.2)

NO CHANGES TO, OR SUBSTITUTIONS FOR THESE APPROVED FINISH MATERIALS AND COLORS MAY BE MADE WITHOUT THE APPROVAL OF THE ARCHITECT AND THE DESIGN REVIEW COMMITTEE.

ARCHITECT TO FIELD VERIFY ALL FINISH MATERIALS AND COLORS PRIOR TO FINAL APPLICATION.

DESCRIPTION COLOR NAME TO MATCH FRAZEE: WITH SOLAR REFLECTIVE INDEX 8773M DAUPHIN GREY ICE/WATER MEMBRANE OVER ENTIRE ROOF SURFACE UP TO 24" DOWN FROM RIDGE TYP. B SHIPLAP SIDING BORAL SYNTHETIC MATERIAL OVER TYVEC DUNN EDWARDS HOME WRAP.

LRV 87 DEM340 WHISPER DUNN EDWARDS MATERIAL OVER TYVEC LRY 87 DEW340 WHISPER HOME WRAP. 2 1/2" THICK ADHERED STONE RUBBLE (LOCALY SOURCED) CREAM/ TAN MINDOMS/ DOORS ALUMINUM CLAD MOOD WINDOMS AND DOORS WITH INSULATED GLASS COLOR TO MATCH SIDING DUNN EDWARDS LRY 80 DE5028 FAIRY WINGS PAINTED WOOD MAIN ENTRY W/INSULATED GLASS PASSAGE DOORS/ ALUMINUM CLAD WOOD DOORS MECH. DOORS WITH INSULATED GLASS WHERE COLOR TO MATCH SIDING APPLICABLE CUSTOM WOOD SECTIONAL (PAINTED TO MATCH WALLS) GARAGE DOOR COLOR TO MATCH SIDING

COLOR TO MATCH SIDING GUARD RAILS VENEERED W/ BORAL SYNTHETIC METERIAL CUSTOM BRASS GUTTER & DOWNSPOUT TO DRAIN TO SUB-TERRANIAN GUTTERS & DOWNSPOUTS MATCH ROOF COLOR FOUNDATION DRAIN. COLOR TO MATCH SIDING BORAL SYNTHETIC METERIAL

GARDEN WALLS STACKED STONE RUBBLE CREAM/ TAN M FOUNDATION COLOR TO MATCH SIDING WALLS @ HOUSE

SPJ LIGHTING SPJ29-02A LIGHT FIXTURES TO MATCH ROOF STEEL TO MATCH ROOF

BEIGE

LIMESTONE

ation E rior

DRAWN

CHECKED

DATE


2/3/2023 REVISION

SCALE

1/4" = 1'-0"

SHEET NO.

R.K.

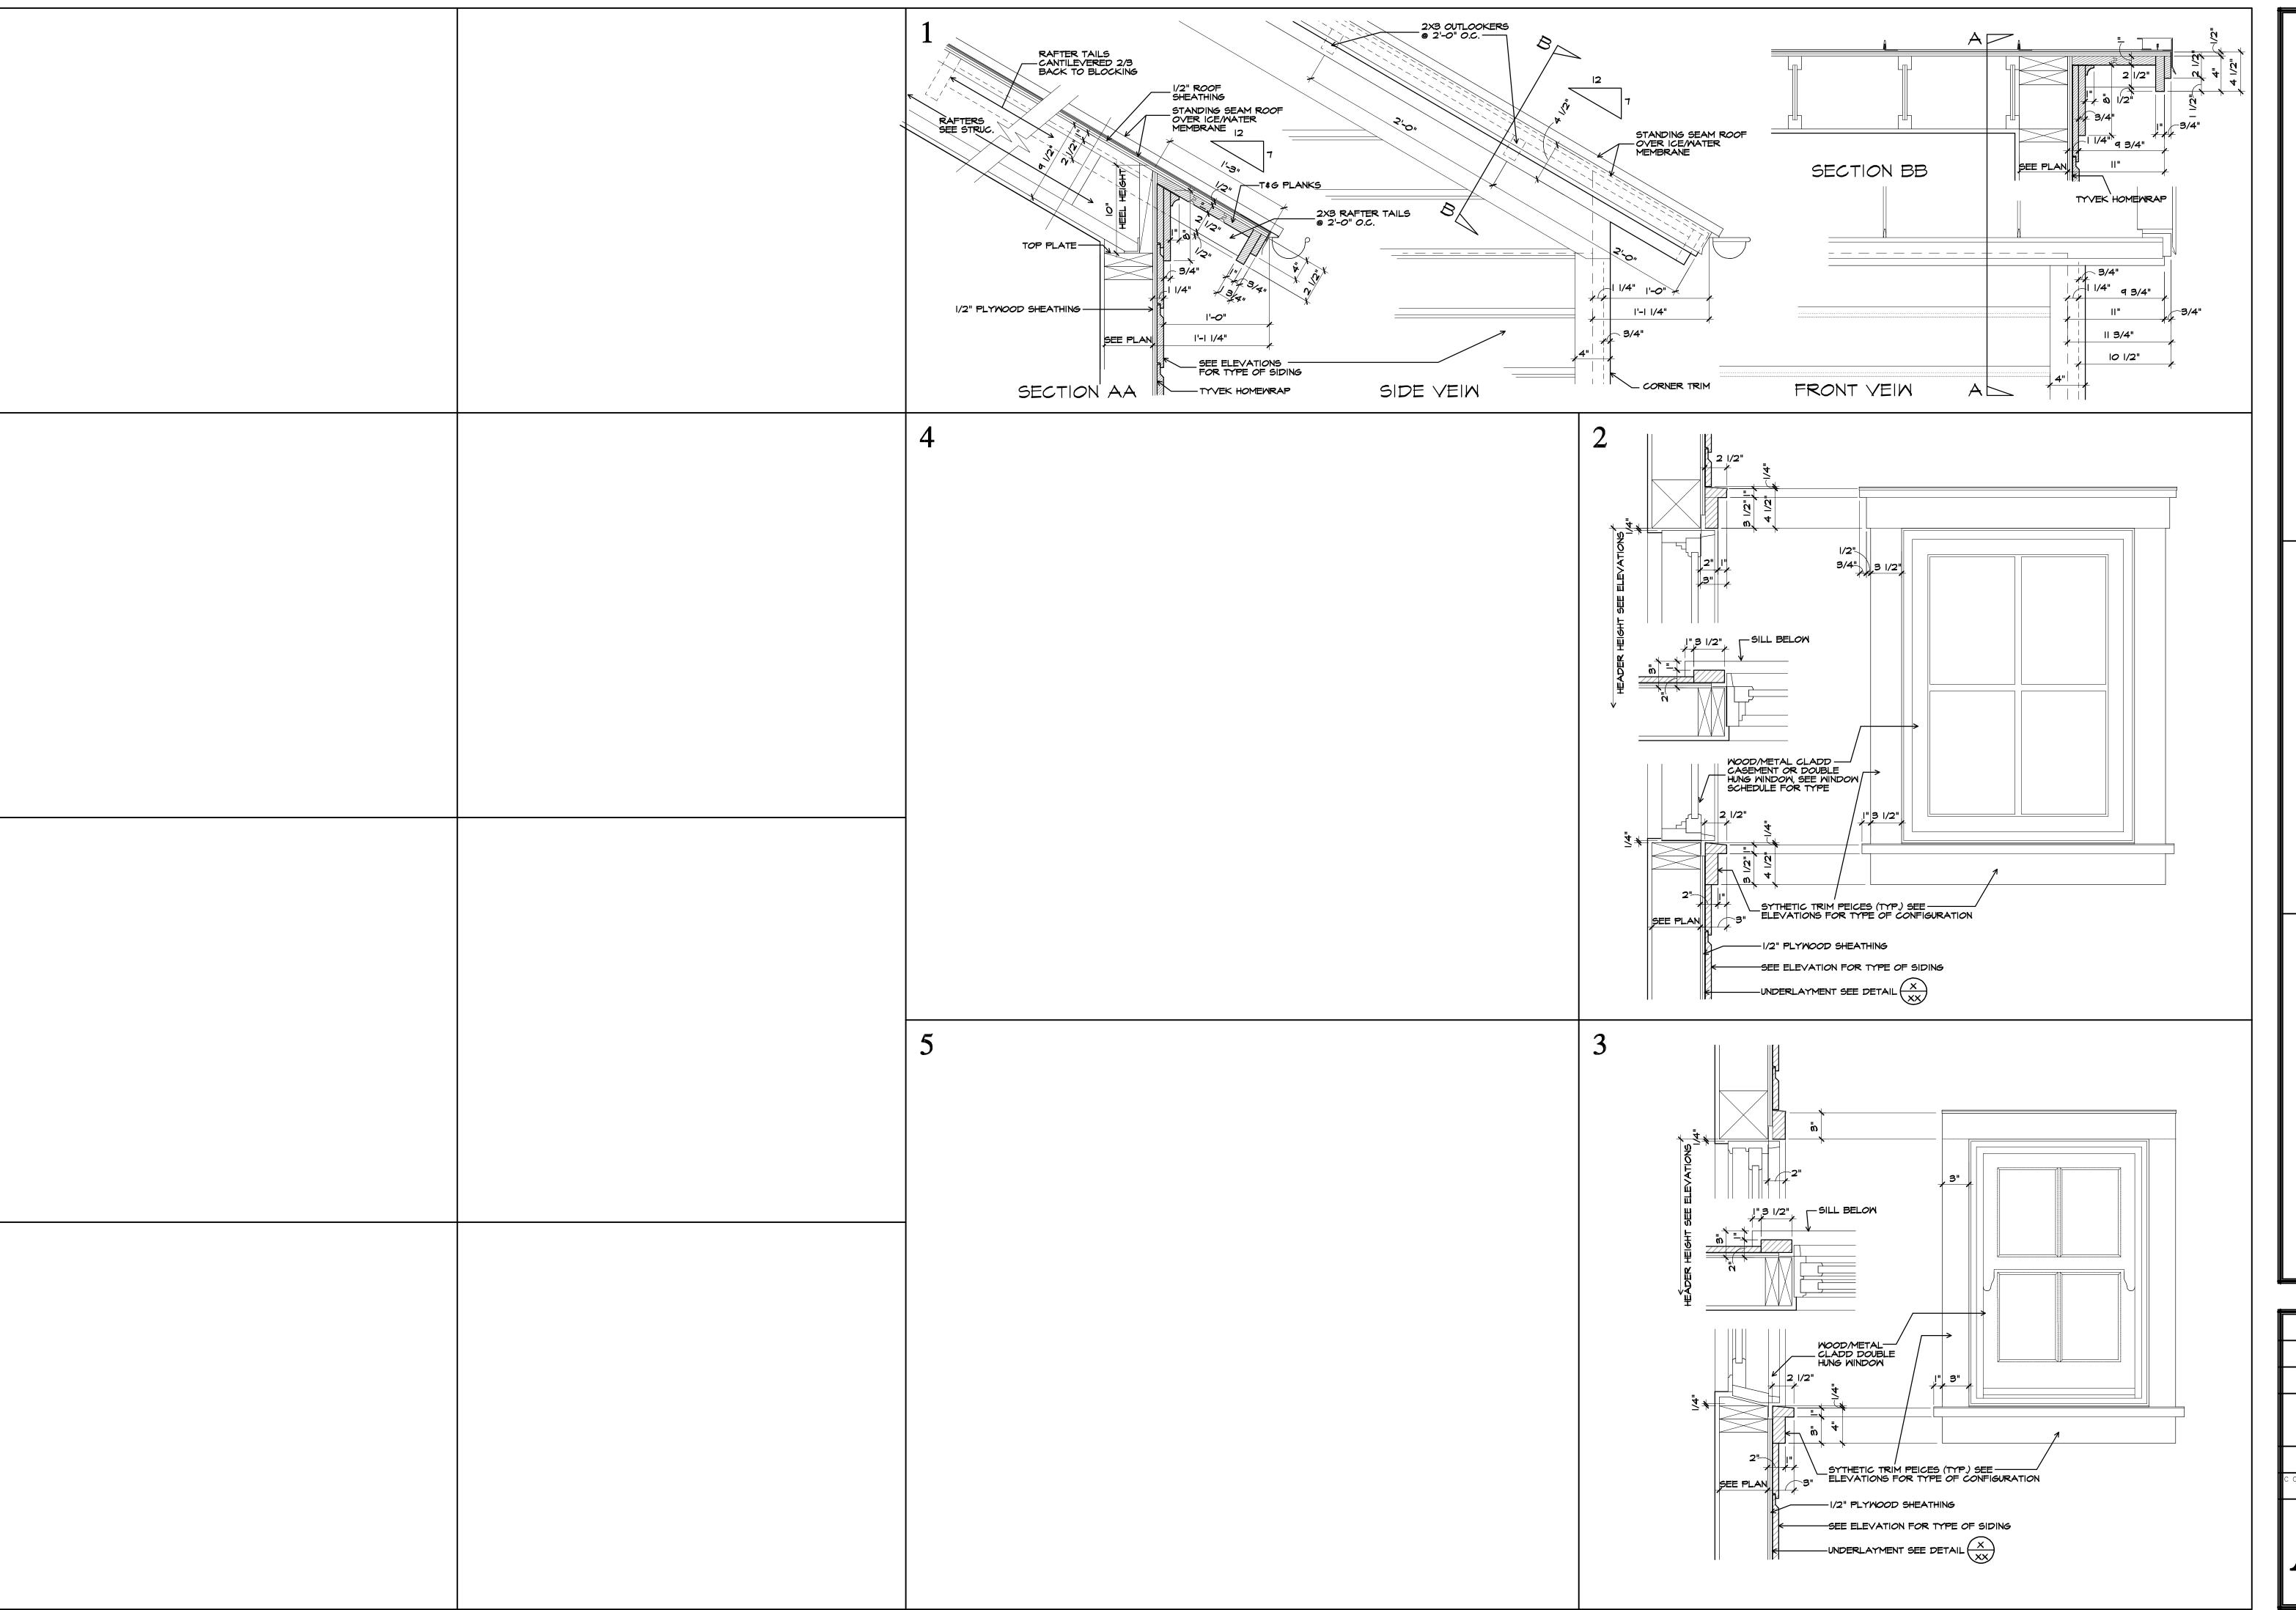




Krantz

Richard Details nitectural Arck

475 Woodside Avenue Park City, UT 84060 DRAWN CHECKED R.K. D A T E 11/28/2022 SCALE CODE COMPLIANCE N SHEETNO.

Hoch Residence

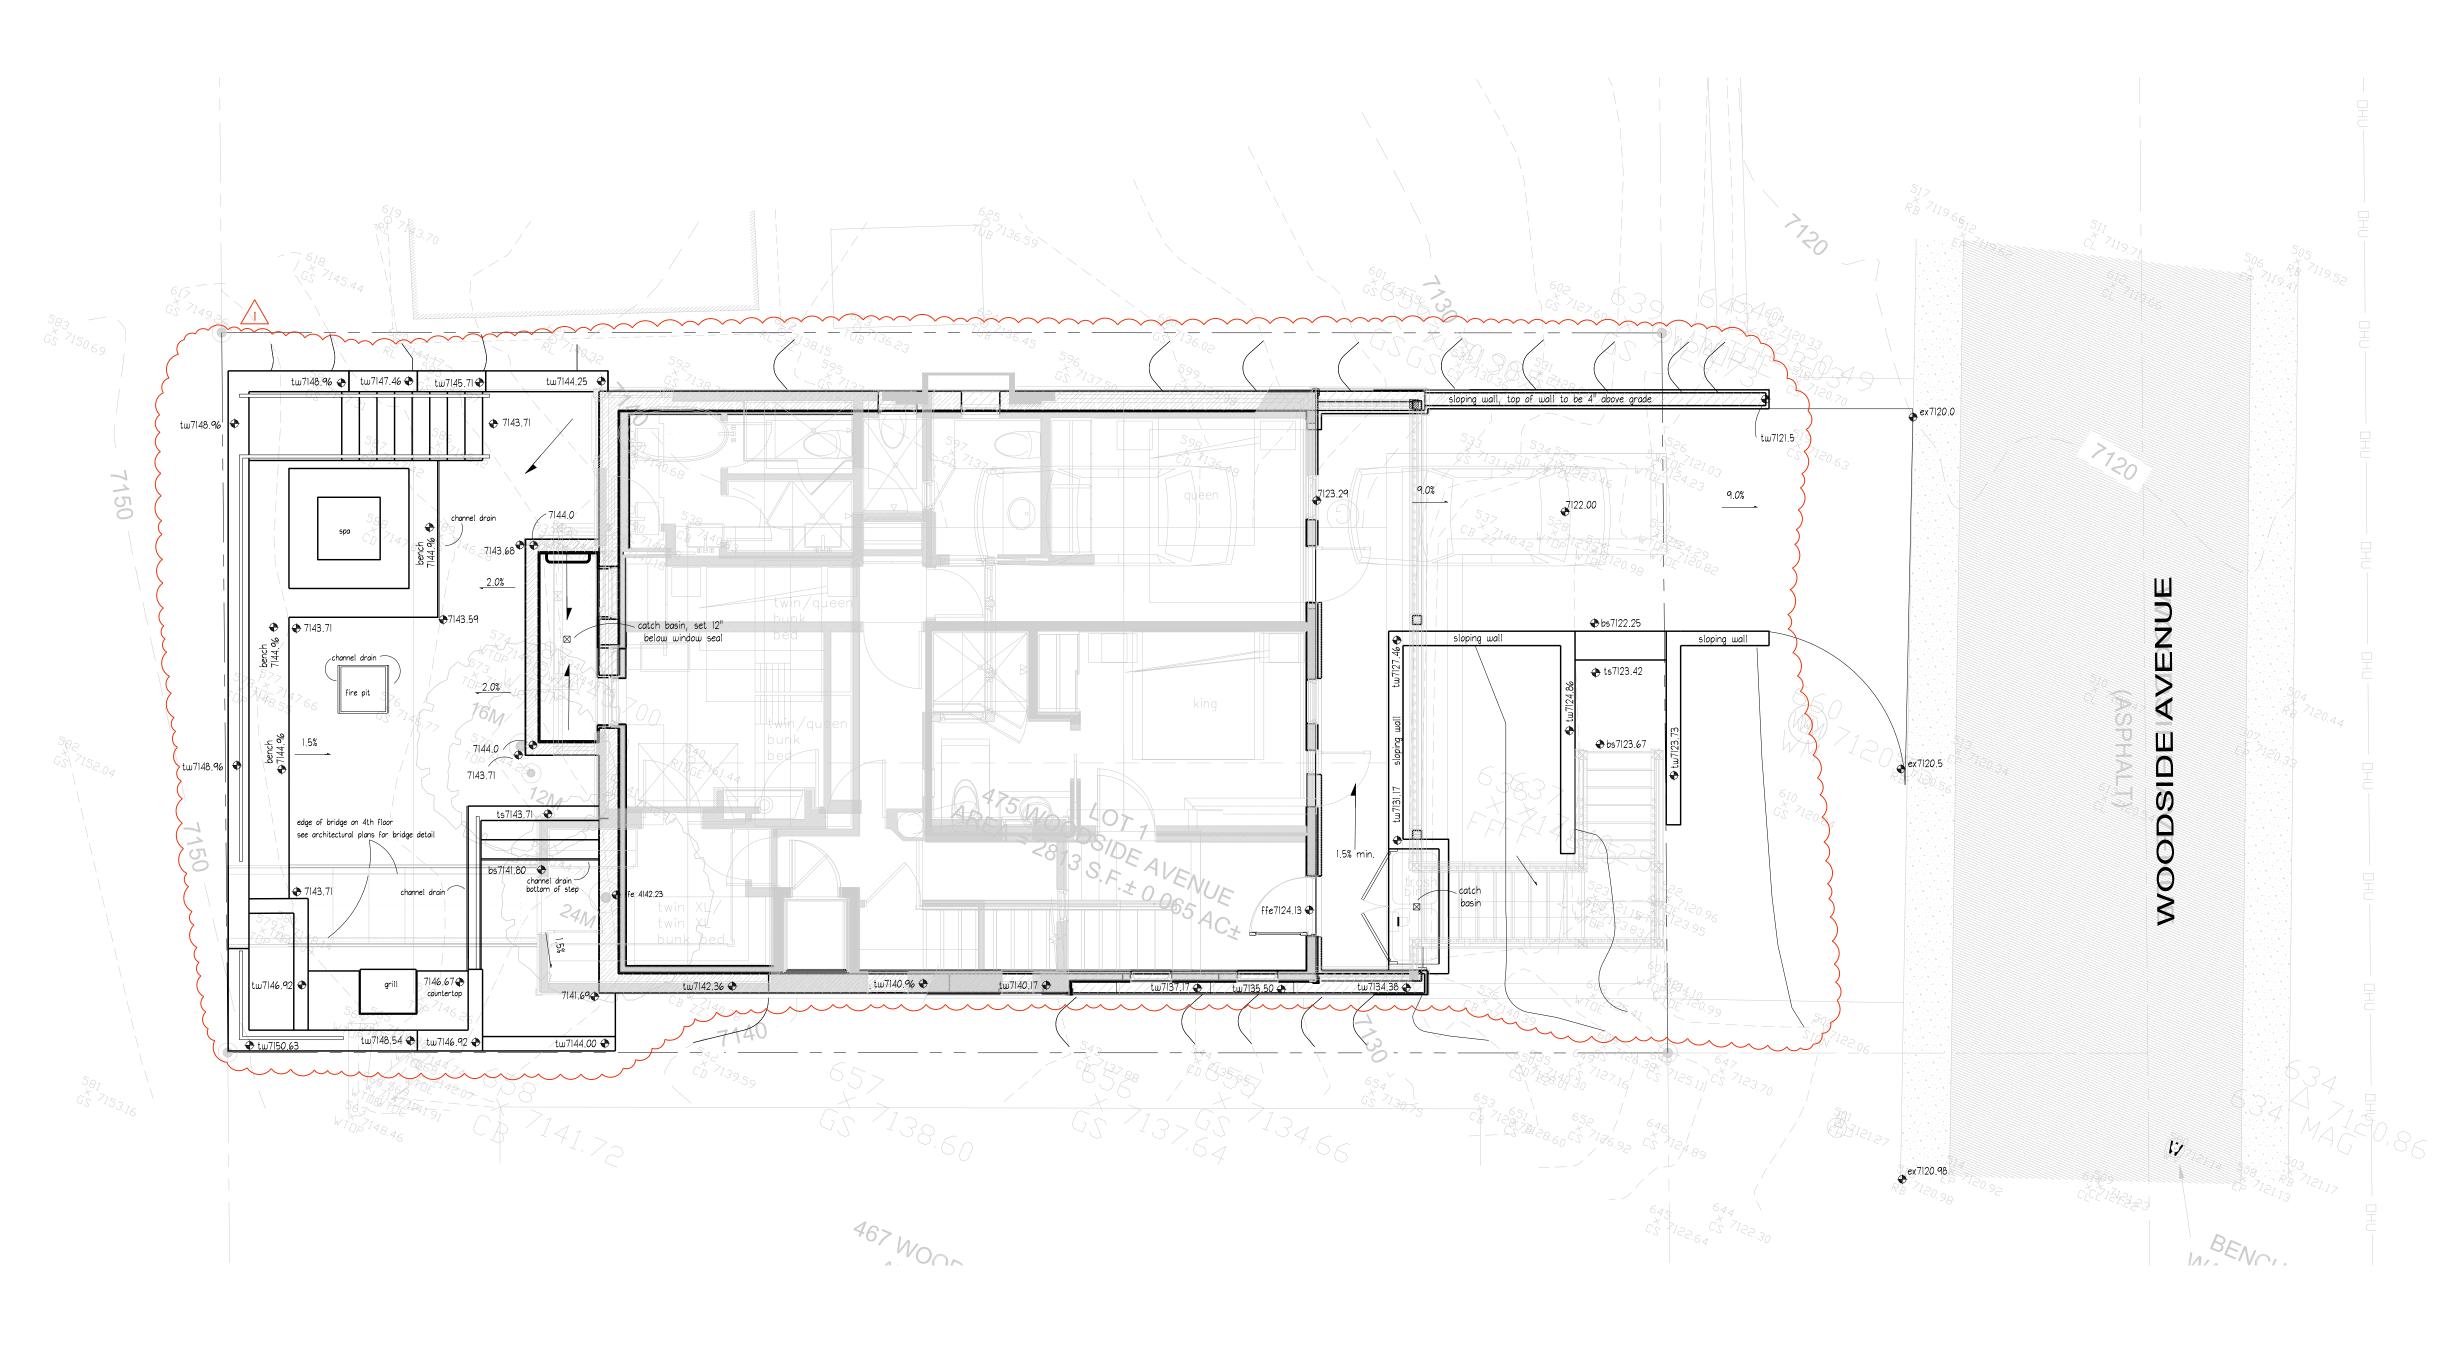


GRADING & LAYOUT NOTES

FINISHED GRADES, CONTOURS, AND ELEVATIONS INDICATED ON THE GRADING AND DRAINAGE PLAN DESCRIBE FINAL SURFACE ELEVATIONS FOR COMPLETED CONSTRUCTION. THE CONTRACTOR SHALL REVIEW THE DETAILS AND SPECIFICATIONS TO ASCERTAIN SPECIFIC WORK LIMITS AND REQUIREMENTS.

- 2. CONTRACTOR SHALL VERIFY ALL EXISTING GRADES IN THE FIELD AND REPORT ANY DISCREPANCIES TO THE OWNER'S REPRESENTATIVE.
- 3. CONSULT ALL OF THE DRAWINGS AND SPECIFICATIONS FOR COORDINATION REQUIREMENTS BEFORE COMMENCING CONSTRUCTION.
- 4. WHERE NEW PAVING OR EARTHWORK MEETS EXISTING PAVING OR EARTHWORK SMOOTHLY BLEND LINE AND GRADE OF EXISTING WITH NEW. ALL RIDGES AND VALLEYS SHALL HAVE A SMOOTH TRANSITIONS.
- 5. GRADE EVENLY BETWEEN SPOT GRADES SHOWN ON DRAWINGS. ALL PAVED AREAS MUST GRADE TO DRAIN AT A MINIMUM OF ONE-EIGHTH INCH (1/8") PER FOOT. ANY DISCREPANCIES NOT ALLOWING THIS TO OCCUR SHALL BE REPORTED TO THE OWNERS REPRESENTATIVE PRIOR TO CONTINUING WORK.
- 6. PRIOR TO COMMENCING ANY EXCAVATION WORK, THE CONTRACTOR SHALL NOTIFY ALL UTILITY COMPANIES IN ACCORDANCE WITH THE REQUIRED PROCEDURES.
- 7. THE LOCATION OF UNDERGROUND UTILITIES SHOWN ON THIS PLAN ARE DIAGRAMMATIC ONLY, AND ALL UTILITIES MAY NOT BE SHOWN. THE CONTRACTOR SHALL CONTACT THE PROPER LOCAL AUTHORITIES OR RESPECTIVE UTILITY COMPANY TO CONFIRM THE LOCATION OF ALL EXISTING UTILITIES BEFORE COMMENCING WORK. ANY DAMAGE DUE TO FAILURE OF THE CONTRACTOR. TO CONTACT THE PROPER AUTHORITIES SHALL BE BORNE BY THE CONTRACTOR.
- 8. EXCAVATION REQUIRED WITHIN PROXIMITY OF EXISTING UTILITY LINES SHALL BE DONE BY HAND. CONTRACTOR SHALL REPAIR ANY DAMAGE TO EXISTING UTILITY LINES OR STRUCTURES INCURRED DURING CONSTRUCTION OPERATIONS AT NO COST TO OWNER.
- 9. ANY AREA DISTURBED OUTSIDE THE LIMIT OF DISTURBANCE/PROPERTY LINE SHALL BE RESTORED TO ITS ORIGINAL CONDITIONS AT NO COST TO OWNER.
- 10. CONTRACTOR SHALL SUPPLY AND MAINTAIN FOR THE DURATION OF CONSTRUCTION ALL NECESSARY DEVICES FOR EROSION, SEDIMENT AND DUST CONTROL, SUCH AS HAY BALES, GRAVEL, BOARDS, ETC., INCLUDING THOSE DEVICES NECESSARY FOR STOCKPILES AND PROTECTION OF ADJACENT PUBLIC WAYS AND SHALL REMOVE THE DEVICES AFTER PROJECT CLOSEOUT.
- II. REFER TO STRUCTURAL DETAILS AND RECOMMENDATIONS FOR ROCK WALL CONSTRUCTION.
- 12. CUT AND FILL SLOPES SHALL BE CONSTRUCTED AS RECOMMENDED BY THE GEOTECHNICAL REPORT.
- 13. INSTALL DRAINAGE PIPE ON BACKSIDE OF RETAINING WALLS AND SLOPE TO DAYLIGHT DRAINS AS REQUIRED

SCALE \$ NORTH ARROW

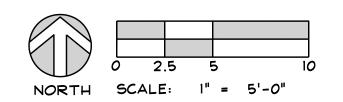

Are Sitio Design, Inc Landscape Architecture & Architectural Site Design

1058 East 2100 South Salt Lake City, Utah 84106 office 801 . 487 . 4923 fax 801 . 466 . 3046 www.arcsitiodesign.com



consultant:

projec

475 Woodside Residence

date

revisions

MAY 10, 2022

2/13/2023


data asd project i

lo

title GRADING PLAN

sheet

LG101

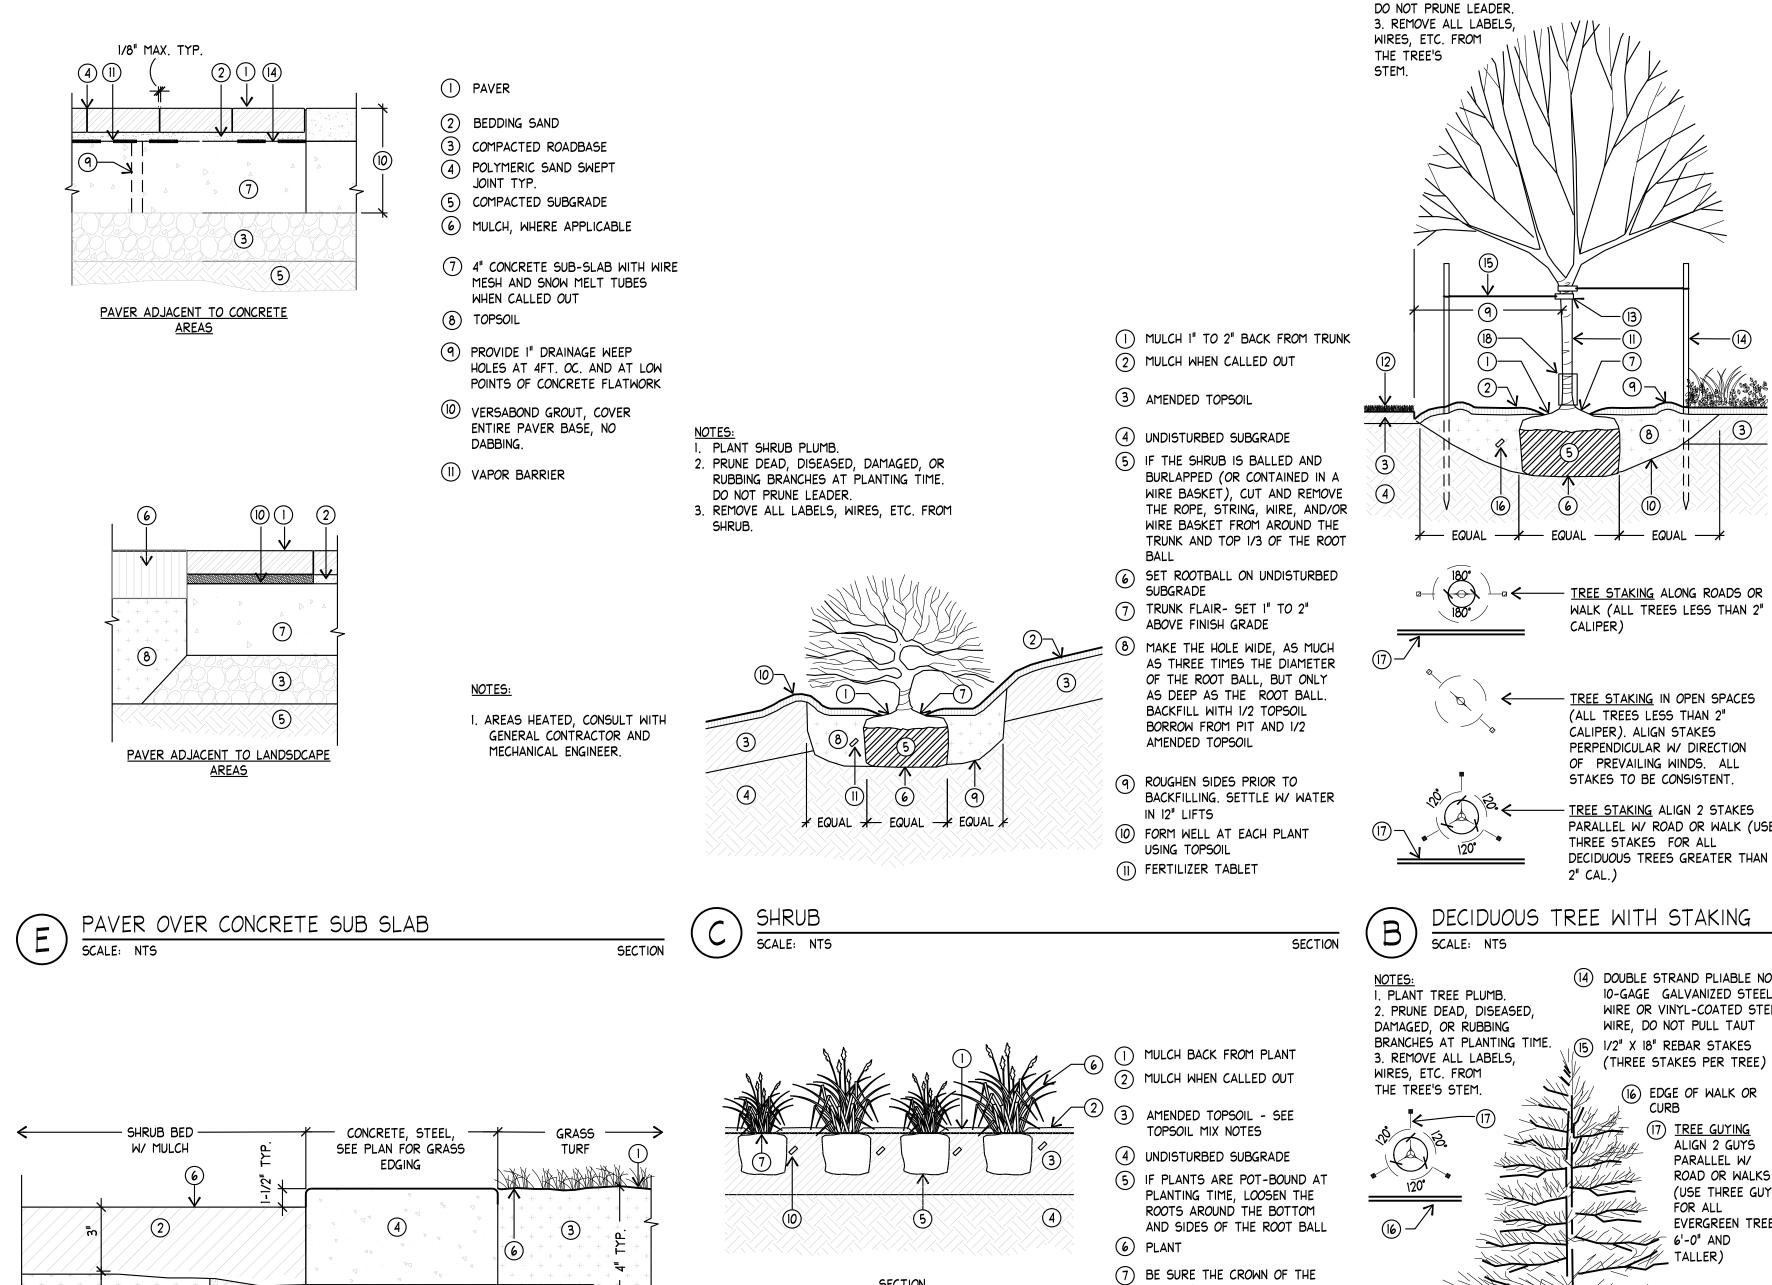

3

MULCH WITH TOPSOIL

SCALE: NTS

(5)

(7) ROAD BASE, WHEN

APPLICABLÉ

1 TURF GRASS

3 AMENDED TOPSOIL

(4) LANDSCAPE EDGING

(5) SUBGRADE

6 FINISH GRADE

(2) PEP SOIL FINE MULCH, OR

<u>SECTION</u>

<u>PLAN</u>

PERENNIAL / GROUNDCOVER

SCALE: NTS

PLANTING NOTES

CONTRACTOR SHALL BE RESPONSIBLE FOR MAKING HIMSELF FAMILIAR WITH ALL UNDERGROUND UTILITIES, PIPES AND STRUCTURES. CONTRACTOR SHALL TAKE SOLE RESPONSIBILITY FOR ANY COSTS INCURRED DUE TO DAMAGE OF SAID UTILITIES.

CONTRACTOR SHALL NOT WILLFULLY PROCEED WITH CONSTRUCTION AS DESIGNED WHEN IT IS OBVIOUS THAT OBSTRUCTIONS AND/OR GRADE DIFFERENCES EXIST THAT MAY NOT HAVE BEEN KNOWN DURING DESIGN. SUCH CONDITIONS SHALL BE IMMEDIATELY BROUGHT TO THE ATTENTION OF THE OWNERS REP. THE CONTRACTOR SHALL ASSUME FULL RESPONSIBILITY FOR ALL NECESSARY REVISIONS DUE TO FAILURE TO GIVE SUCH NOTIFICATION.

- CONTRACTOR SHALL BE RESPONSIBLE FOR ANY COORDINATION WITH SUBCONTRACTORS AS REQUIRED TO ACCOMPLISH THE LANDSCAPE CONSTRUCTION FOR THIS PROJECT.
- ALL PLANT MATERIAL SHALL BE APPROVED BY THE OWNER'S REPRESENTATIVE UPON DELIVERY TO THE SITE, AND PRIOR TO INSTALLATION. ANY PROPOSED SUBSTITUTIONS OF PLANT SPECIES SHALL BE MADE WITH PLANTS OF EQUIVALENT OVERALL FORM, HEIGHT, BRANCHING HABIT, FLOWER, LEAF, COLOR, FRUIT AND CULTURE ONLY AS APPROVED BY THE OWNER'S REPRESENTATIVE.
- THE CONTRACTOR SHALL SUPPLY ALL PLANT MATERIAL IN QUANTITIES SUFFICIENT TO COMPLETE THE PLANTING SHOWN ON THE DRAWINGS. IF DISCREPANCIES ARISE BETWEEN ACTUAL PLANTING AREA SIZES IN THE FIELD AND THOSE SHOWN ON THE PLANS, CONTRACTOR SHALL CONTACT THE OWNER'S REPRESENTATIVE FOR RESOLUTION. FAILURE TO MAKE SUCH CONFLICTS KNOWN WILL RESULT IN CONTRACTOR'S LIABILITY FOR MATERIALS RELOCATION.
- FINAL LOCATIONS OF ALL PLANT MATERIALS SHALL BE SUBJECT TO APPROVAL OF THE OWNER'S REPRESENTATIVE. TREES SHALL NOT BE PLANTED LESS THAN 5'-0" FROM CURBS OR HARD SURFACE AREAS UNLESS A ROOT BARRIER IS INSTALLED.
- CONTRACTOR SHALL PROVIDE SOIL ANALYSIS AND AMMEND SOIL AS RECOMMENDED. LANDSCAPE CONTRACTOR IS RESPONSIBLE FOR THE LAST 7 INCHES OF GRADE IN TURF SOD AREAS (6 INCHES OF TOPSOIL AND 1 INCH FOR SOD) AND 15 INCHES IN SHRUB BED AREAS (3 INCHES OF BARK MULCH AND 12" OF AMENDED TOPSOIL). IF NECESSARY DIG SUBGRADE IN SHRUB BEDS AND TURF AREAS DOWN AS SPECIFIED BEFORE PLACING AMENDED TOPSOIL. THE PLANTING ISLANDS IN THE PARKING LOTS SHALL HAVE ALL ROAD BASE REMOVED PRIOR TO PLACEMENT OF TOPSOIL. REFER TO GRADING PLAN FOR FINISH GRADE AND DRAINAGE.

<u>DECIDUOUS</u>	BOTANICAL NAME	COMMON NAME	CONT	CAL	<u>SIZE</u>
	Acer buergerianum	Trident Maple	B # B	2"	
EVERGREEN	BOTANICAL NAME	COMMON NAME	CONT	CAL	<u>SIZE</u>
o de la companya de l	Pinus sylvestris 'Glauca Nana'	Dwarf Scotch Pine	B & B	SPECIMEN	-
SHRUBS	BOTANICAL NAME	COMMON NAME	SIZE		
rib	Ribes alpinum	Alpine Currant	5 gal		٨
(sym)	Symphoricarpos albus	Common White Snowberry	5 gal		1
<u>GRASSES</u>	BOTANICAL NAME	COMMON NAME	<u>SIZE</u>		
	Calamagrostis acutifolia 'Overdam'	Overdam Reed Grass	l gal		
	Festuca mairei	Atlas Fescue	l gal		
PERENNIALS	BOTANICAL NAME	COMMON NAME	SIZE		
	Aquilegia alpina	Alpine Columbine	l gal		
rr	Hemerocallis hybrid 'Rosy Returns'	Rosy Returns Daylily	l gal		
(ir)	Iris pallida 'Aureo Variegata'	Variegated Yellow Blade Iris	l gal		
(ag)	Nepeta x faassenii 'Blue Wonder'	Catmint	l gal		
(nit)	Rudbeckia fulgida 'Goldsturm'	Goldsturm Black-eyed Susan	l gal		

* QUANTITY INFORMATION PROVIDED FOR REFERENCE ONLY. CONTRACTOR RESPONSIBLE TO VERIFY ALL QUANTITIES.

REFERENCE SCHEDULE NOTES

(1) MULCH I" TO 2" BACK FROM TRUNK

(3) AMENDED TOPSOIL- SEE TOPSOIL

5 IF THE TREE IS BALLED AND BURLAPPED (OR CONTAINED IN A

6 SET ROOTBALL ON UNDISTURBED

(8) MAKE THE HOLE WIDE, AS MUCH AS THREE TIMES THE DIAMETER OF THE ROOT BALL, BUT ONLY

AS DEEP AS THE ROOT BALL.

BACKFILL WITH 1/2 TOPSOIL

BORROW FROM PIT AND 1/2

AMENDED TOPSOIL- SEE

(9) REMOVE SOD AT DRIPLINE OF

MIN. WIDTH OF 3'-0" DIA.

ROUGHEN SIDES PRIOR TO

(II) IF PLANTED IN LATE FALL, WRAP

BOTTOM TO THE FIRST SET OF

BRANCHES. REMOVE THE WRAP

FROST. ONLY WRAP IF SUN HITS

TRUNK, STARTING AT THE

SPRING, AFTER THE LAST

) DO NOT PLANT LAWN IN TREE

(13) 3" OR WIDER NYLON WEBBING W/

STAKES, TWO PER TREE (THE

STAKES SHALL BE PLUMB AND

SET AT THE SAME HIEGHT)

10-GAGE GALVANIZED STEEL

WIRE, DO NOT PULL TAUT

TURF / GRASS SEED AREAS

SECTION

(16) FERTILIZER TABLET

(3) AMENDED TOPSOIL

(USE THREE GUYS 6 SET ROOTBALL ON UNDISTURBED SUBGRADE

EVERGREEN TREES

TRUNK FLAIR- SET I" TO 2"

ABOVE FINISH GRADE

4 UNDISTURBED SUBGRADE

IF THE TREE IS BALLED AND

BURLAPPED (OR CONTAINED IN A

WIRE BASKET), CUT AND REMOVE

WIRE BASKET FROM AROUND THE

TRUNK AND TOP 1/3 OF THE ROOT

(8) MAKE THE HOLE WIDE, AS MUCH

AS THREE TIMES THE DIAMETER

OF THE ROOT BALL, BUT ONLY

AS DEEP AS THE ROOT BALL.

TREE TO FORM TREE WELL OR A

BACKFILLING. SETTLE W/ WATER

SECTION

BACKFILL WITH 1/2 TOPSOIL

BORROW FROM PIT AND 1/2

(9) REMOVE SOD AT DRIPLINE OF

MIN. WIDTH OF 3'-0" DIA.

ROUGHEN SIDES PRIOR TO

) DO NOT PLANT LAWN IN TREE

(12) 3" OR WIDER NYLON WEBBING W/

METAL GROMMETS

(13) FERTILIZER TABLET

IN 12" LIFTS

AMENDED TOPSOIL

THE ROPE, STRING, WIRE, AND/OR

PARALLEL W/ ROAD OR WALK (USE (17) EDGE OF WALK OR CURB

DECIDUOUS TREES GREATER THAN (18) TREE GAURD ON ALL TREES IN

(4) DOUBLE STRAND PLIABLE NO. (1) MULCH I" TO 2" BACK FROM TRUNK

WIRE OR VINYL-COATED STEEL 2 MULCH WHEN CALLED OUT

WIRE OR VINYL-COATED STEEL

(15) DOUBLE STRAND PLIABLE NO.

(14) 6'-0" X 2" DIA. ROUND WOOD

ITS TRUNK IN WINTER.

METAL GROMMETS

IN 12" LIFTS

WALK (ALL TREES LESS THAN 2"

TREE STAKING IN OPEN SPACES

(ALL TREES LESS THAN 2"

CALIPER). ALIGN STAKES

PERPENDICULAR W/ DIRECTION

- TREE STAKING ALIGN 2 STAKES

WIRE, DO NOT PULL TAUT

(THREE STAKES PER TREE)

(16) EDGE OF WALK OR

(17) TREE GUYING

ALIGN 2 GUYS

PARALLEL W/

ROAD OR WALKS

CURB

OF PREVAILING WINDS. ALL

STAKES TO BE CONSISTENT.

THREE STAKES FOR ALL

2" CAL.)

DECIDUOUS TREE WITH STAKING

EVERGREEN TREE WITH GUYING

SCALE: NTS

SCALE: NTS

PLANT (THE POINT WHERE

WITH THE SOIL SURFACE

(9) CENTER OF PLANT

FERTILIZER TABLET

(8) PLANT SPACING VARIES - REFER TO PLANT SCHEDULE OR PLAN

I. PRUNE DEAD, DISEASED,

BRANCHES AT PLANTING TIME.

3. WATER PLANTS THOROUGHLY

FOLLOWING PLANTING TO SETTLE THE SOIL AROUND THE ROOTS.

SECTION/PLAN

2. REMOVE ALL LABELS, WIRES,

DAMAGED, OR RUBBING

ETC. FROM PLANT.

ROOTS AND TOP JOIN) IS EVEN

TREE TO FORM TREE WELL OR A

BACKFILLING. SETTLE W/ WATER

TOPSOIL MIX NOTES

7 TRUNK FLAIR- SET I" TO 2"

ABOVE FINISH GRADE

WIRE BASKET), CUT AND REMOVE

THE ROPE, STRING, WIRE, AND/OR WIRE BASKET FROM AROUND THE TRUNK AND TOP 1/3 OF THE ROOT

(2) MULCH WHEN CALLED OUT

(4) UNDISTURBED SUBGRADE

MIX NOTES

SUBGRADE

<u>NOTES:</u> I. PLANT TREE PLUMB.


2. PRUNE DEAD, DISEASED, DAMAGED, OR RUBBING

BRANCHES AT PLANTING TIME.

SYMB <i>o</i> l	DESCRIPTION	
	3" DEEP SOIL PEP MULCH OVER 12" OF TOPSOIL, TYP., 856 sf	
	SEE DETAIL F	
2	3"x3"x3" FRACTURED ALL SIDES BUT ONE SIDE CUT GRANITE COBBLES SET ON HEATED CONCRETE DRIVE, TYP. SEE DETAIL E	
3	6"XI2"XI I/4" BEIGE GRANITE PAVER WITH FLAMED FINISH, OVER HEATED CONCRETE SUB SLAB, TYP. SEE DETAIL E	
4	3/4" TO 1 1/2" TAN CRUSHED GRAVEL, TYP. SEE DETAIL 30 sf	
5	77" \times 77" 6 PERSON HOT TUB, INSTALL PER CODE AND MANUFACTURERS INSTRUCTIONS.	
6	RETAINING WALL, SEE STRUCTURAL, CIVIL, AND ARCHITECTURAL SITE PLAN FOR GRADES	
7	STAIRCASE, SEE ARCHITECTURAL AND SITE PLAN FOR GRADES	
8	BUILT IN BENCH TO SURROUND HOT TUB AND FIRE ELEMENT (ADD CUSHIONS IF DESIRED) STONE VENEEER FACE AND STONE CAP WALL TO MATCH HOUSE STONE	
9	2' 6" \times 2' 6" \times 18" HIGH CORETEN STEEL GAS FIRE ELEMENT, INSTALL PER ALL CODES	
	BBQ GAS GRILL	
12	GRANITE COUNTERTOP	
13	BRIDGE, SEE STRUCTURAL AND ARCHITECTURAL PLANS	
15	EXISTING TREE TO BE REMOVED, SEE DEMOLITION PLAN	
ł	* QUANTITY INFORMATION PROVIDED FOR REFERENCE ONLY. CONTRACTOR RESPONSIBLE TO VERIFY ALL QUANTITIES.	
	\$ NORTH ARROW	

Landscape Architecture & Architectural Site Design

1058 East 2100 South Salt Lake City, Utah 84106 office 801 487 4923 fax 801 . 466 . 3046 www.arcsitiodesign.com

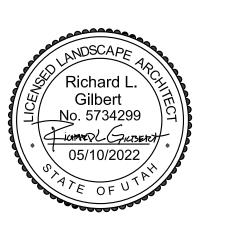

consultant:

project

Woodside Residence Park City, UT

date


MAY 10, 2022

revisions


data asd project no:

LANDSCAPE

sheet

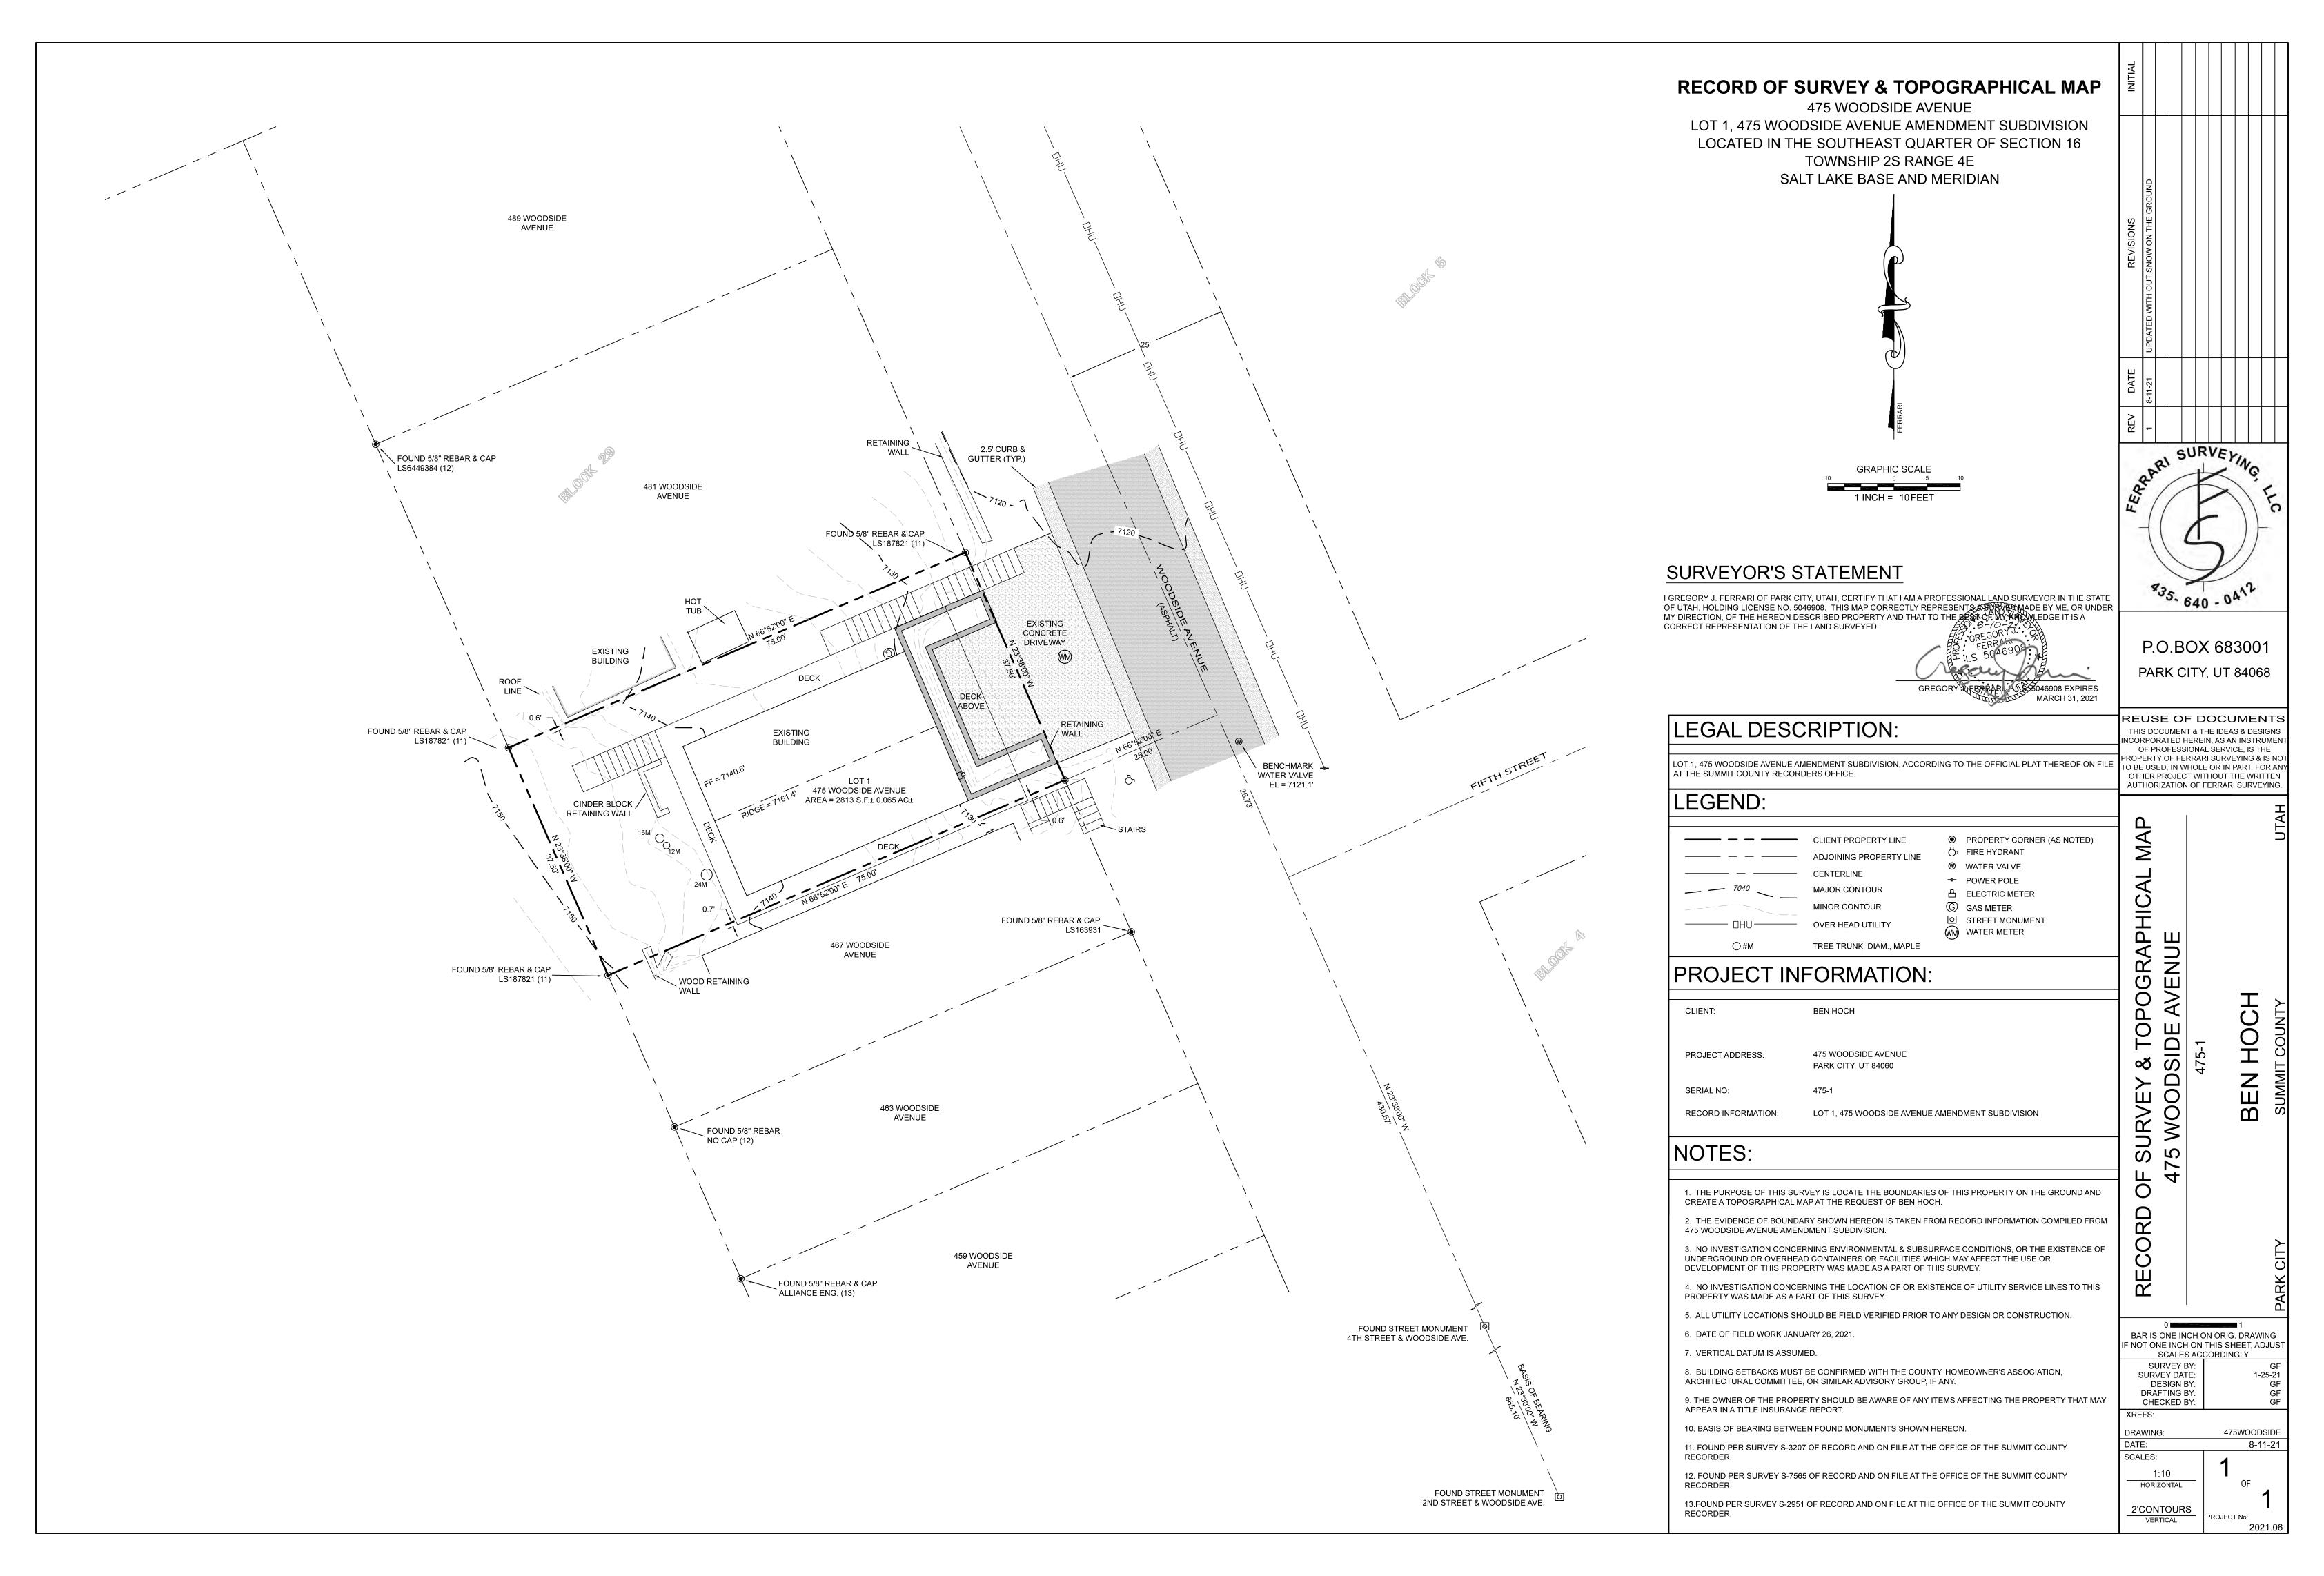

PLAT AMENDMENT AND RELORD OF SURVEY 475 WOODSIDE AVENUE AMENDMENT

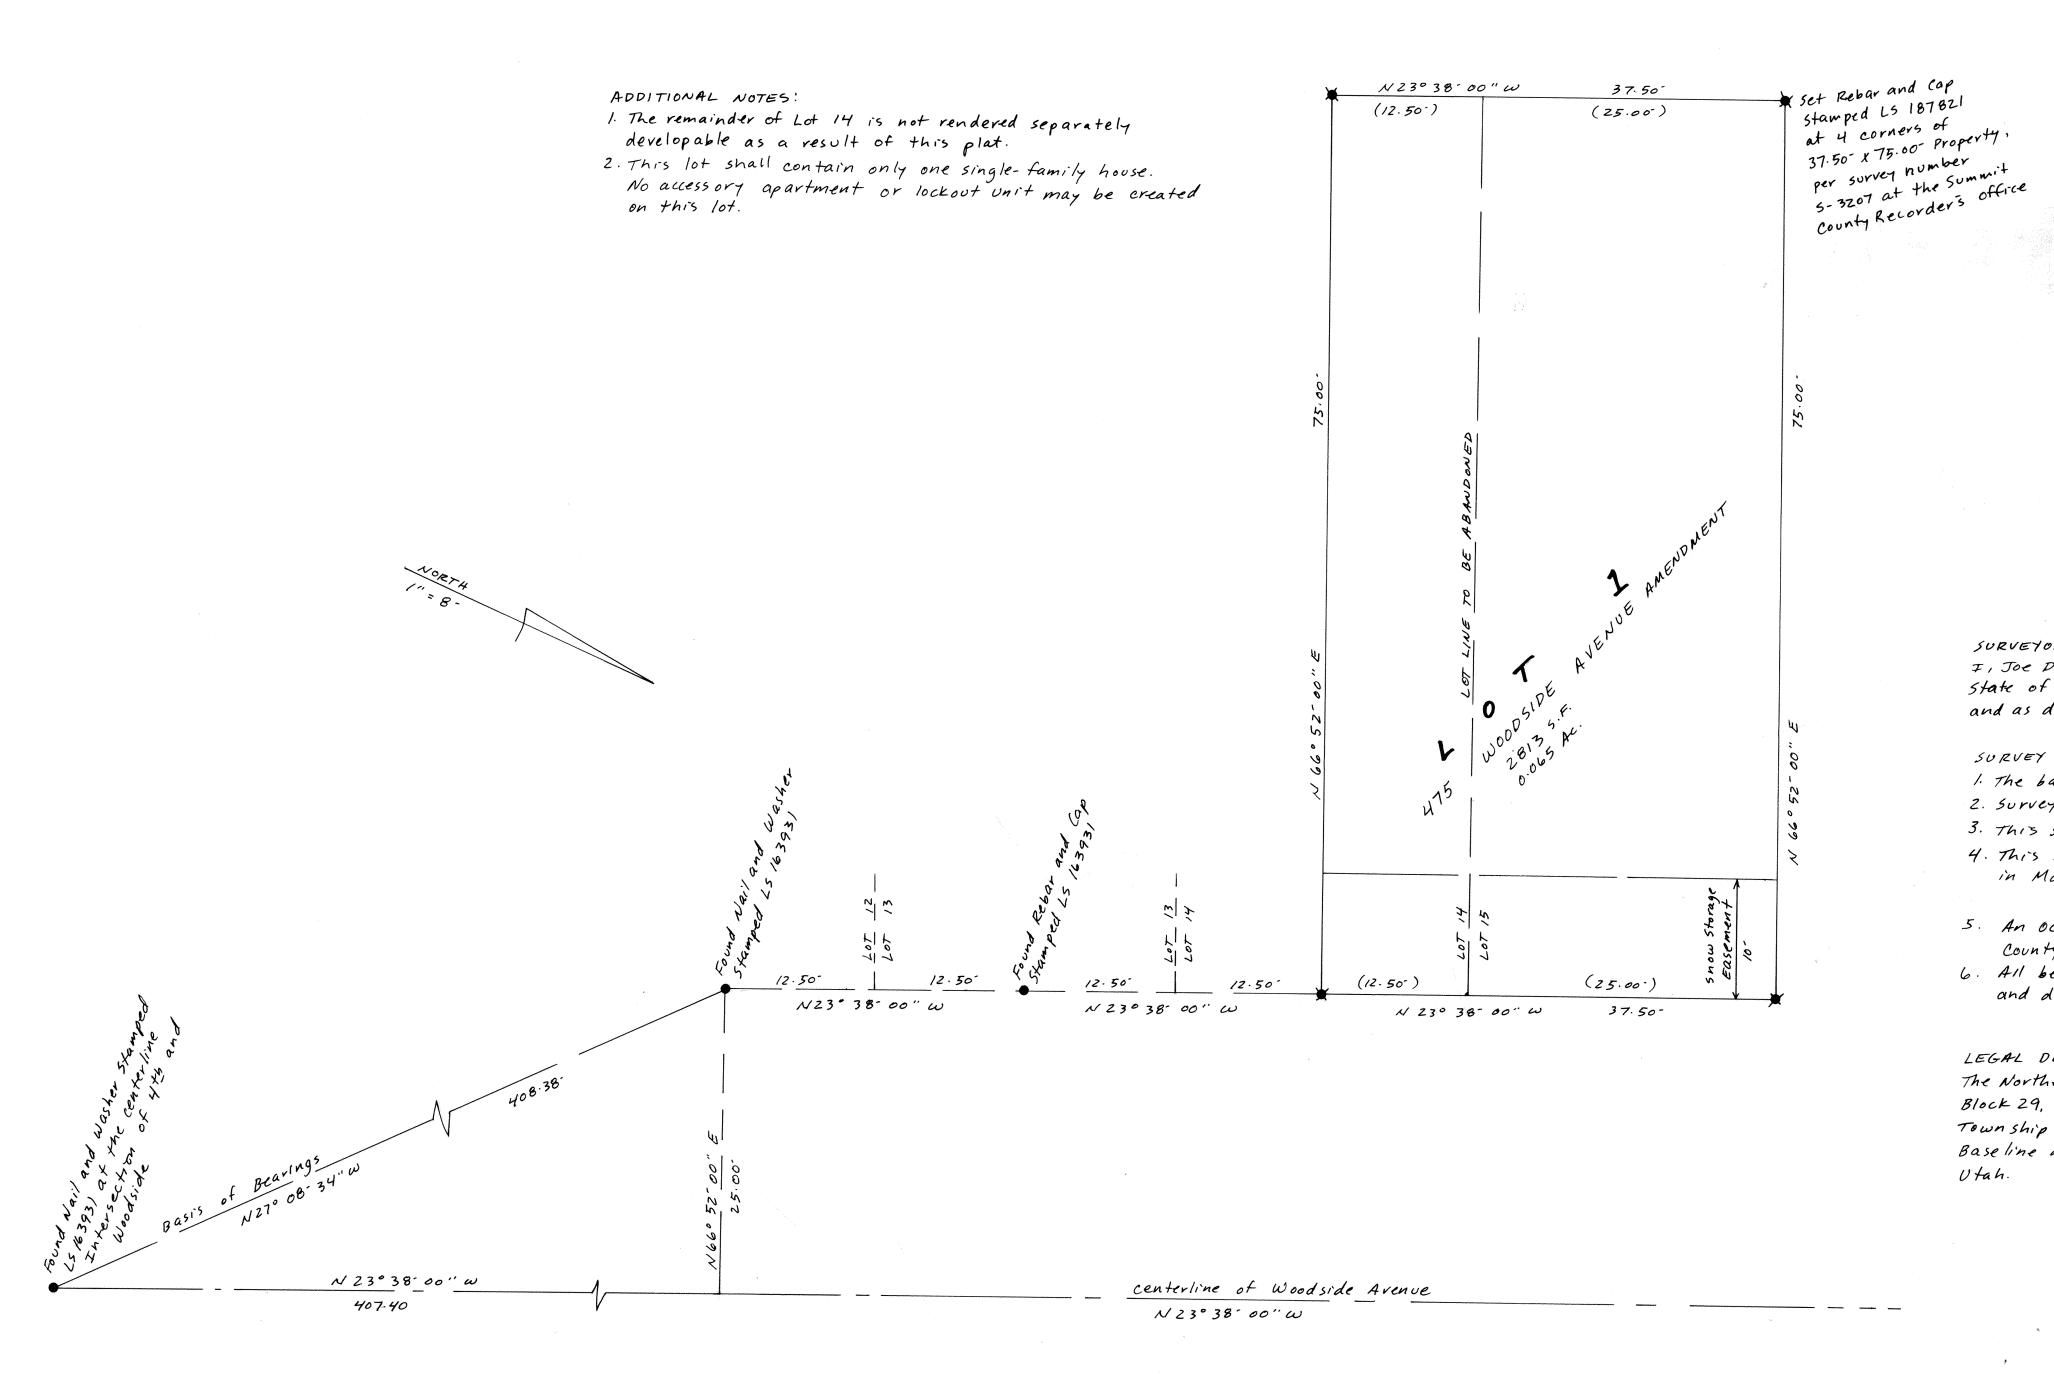

OWNER'S DEDICATION AND CONSENT TO RECORD: Know all men, by these present, that I, Adele D. Langton, as Trustee of the Adele D. Langton Revocable Trust dated June 25, 1992, the owner of the hereon described property, hereinafter to be known as 475 woodside Avenue, certify that I have caused this survey to be made, and the Plat to be prepared, and I do hereby consent to the recordation of this survey and Plat Amendment. The owner hereby offers an irrevocable dedication of easements for public purposes as shown on this plat to Park City in accordance with an irrevocable offer of dedication.

Adele D. Langton, as Trustee of the Adele D. Langton

Revocable Trust dated June 25, 1992.

ACKNOWLEDGEMENT! State of Utah

county of summer on this 24 th day of June, 1999, personally appeared before me, the undersigned notary public in and for said state and County, Adele D. Langton, as Trustee of the Adele D. Langton Revocable Trust dated June 25, 1992, who after being duly sworn, acknowledged to me that she is the owner of the hereon described property, and that she signed the above owner's dedication and consent to record freely and voluntarily.

My Commission Expires

SURVEYOR'S CERTIFICATION!

I, Joe Phaenens, hold license number 187821 as prescribed by the laws of the State of Utah, and certify that I have made a survey of the property shown hereon and as described in the notes and legal description below.

SURVEY NOTES:

1. The basis of bearings is as shown.

2. Survey monuments were found or set as shown.

3. This survey was requested by Adele Langton.


4. This survey was performed in October, 1998, and the Plat Amendment was prepared

5. An october, 1998 survey of the property was recorded as #5-3207 at the summit County Recorder's Office.

6. All bearings and distances shown were measured and are equal to the bearings and distances of the Park City survey and/or other survey's recorded for Block 29.

LEGAL DESCRIPTION:

The Northerly one-half of Lot 14 and all of Lot 15, Block 29, Park City Survey, located in Section 16, Township 2 South, Range 4 East, Salt Lake Baseline and Meridian, park City, Summit County, Utah.

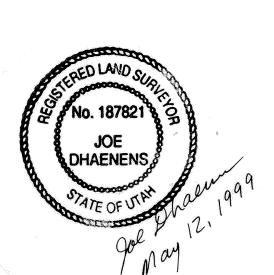

Date 7-7-99

City Council Approved by the Park City Council on this 27th day of MAN, 1999.

City Planning Commission Approved by the Park City Planning Commission on this 30 day of JUNE, 1999.

City Engineer Approved by the Park City Engineer on this 24th day of JUNE,

City Attorney Approved as to form by the Park city Attorney on this 6TH day of Juy, 1999.

Sewer Drstrict Reviewed for conformance to Snyderville Basin Sewer Improvement District standards on this 17 h day of UNC, 1999.

state of Utah. Time 15:53 PM County of Summit. Fee 31.00 Recorded and filed at the request of FIRST AMERICAN TITLE

County Recorder

Number 543463

surveyed by: On The Map Land Surveying P.O. BOX 3864 Park City, UT 84060 647-9826

475 WOODSIDE AVENUE **AMENDMENT**

Recorded

Planning Department Staff Report

Subject: 475 Woodside Avenue

Application: PL-23-05585 Author: Caitlyn Tubbs,

Sr. Historic Preservation Planner

Date: April 20, 2023

Type of Item: Steep Slope Conditional Use Permit

<u>Recommendation</u>

(I) Review the proposed project, (II) conduct a public hearing, and (III) consider approving the proposed Steep Slope Conditional Use Permit for a new Single-Family Dwelling at 475 Woodside Avenue based on the Findings of Fact, Conclusions of Law, and Conditions of Approval outlined in the Draft Final Action Letter (Exhibit A).

Description

Applicant: Ben and Holly Hoch, represented by Richard Krantz

Location: 475 Woodside Avenue
Zoning District: Historic Residential-1 (HR-1)
Adjacent Land Uses: Residential, Open Space

Reason for Review: LMC §15-2.2-6(B)(1) states Administrative Steep Slope

Conditional Use Permits be processed by the Planning Department when development is proposed for Lots 3,750

square feet or less in size.

HDDG Historic District Design Guidelines
HDDR Historic District Design Review
HPB Historic Preservation Board
HR-1 Historic Residential-1 Zone
HSI Historic Sites Inventory
LMC Land Management Code

PCMC Park City Municipal Corporation
SSCUP Steep Slope Conditional Use Permit

Terms that are capitalized as proper nouns throughout this staff report are defined in LMC § 15-15-1.

Summary

475 Woodside Avenue is in the Historic Residential 1 (HR-1) Zoning District and an existing A-frame Structure is located on the site. The existing Structure is not listed on the Historic Sites Inventory (HSI) and was constructed in 1966. The Applicant has proposed the demolition of the existing Structure and the construction of a new Single-Family Dwelling (SFD).



Background

The Applicant submitted a Historic District Design Review on July 13, 2022. The Applicant provided an updated plans submittal on October 11, 2022 and another on December 16, 2022. Planning Staff brought the proposal to the Design Review Team (DRT) on January 25, 2023 where the Applicant was in attendance. Following the meeting with the DRT the Applicant submitted an updated set of plans on February 3, 2023. On February 28, 2023 the Applicant submitted a Steep Slope Conditional Use Permit (SSCUP) application due to the steepness of the slope on the site.

Analysis

The Planning Director has the authority to take Final Action on SSCUP applications on Lots 3,750 square feet or less in size. Staff has outlined the applicable regulations and analyzed the proposal's compliance in the following tables.

(I) The proposal complies with Development on Steep Slope criteria outlined in LMC §15-2.2-6(C).

There are certain Uses that, because of unique characteristics or potential impacts on the municipality, surrounding neighbors, or adjacent land Uses, may not be Compatible in some Areas or may be Compatible only if certain conditions are required that mitigate or eliminate the detrimental impacts.

Development on Steep Slopes must be environmentally sensitive to hillside areas, carefully planned to mitigate adverse effects on neighboring land and improvements, and consistent with the Design Guidelines for Historic Districts (LMC §15-2.2-6).

LMC <u>§15-2.2-6(B)(2)</u> requires a SSCUP for construction of any addition to an existing structure, when the Building Footprint is in excess of 200 square feet and is located on or projecting over an existing Slope of 30% or greater. SSCUP Applications are subject to the following criteria:

Criteria	Analysis of Proposal
LOCATION OF	Complies – The proposed SFD is sited two feet
DEVELOPMENT – development is located and designed to reduce visual and environmental impacts of the Structure.	closer to the Front Lot Line (12' setback) than the Existing Dwelling (14' setback) and is compatible with the siting of neighboring Structures. The proposed SFD will face Woodside Avenue and provide a front entrance along the same street. A set of existing retaining walls (built to the Front Lot Line) will be removed and will no longer interrupt
	the Streetscape.

-


¹ LMC §15-2.2-6(B)(2)



Figure 1: Existing Streetscape

VISUAL ANALYSIS – the Applicant must provide the Planning Department with a visual analysis of the project from key Vantage Points to determine potential impacts of the proposed access and building mass and design and to identify the potential for screening, slope stabilization, erosion mitigation, vegetation protection, and other design opportunities.

Complies – The Applicant submitted renderings of the proposed Dwelling within the existing Streetscape; the proposed SFD is comparable in size, height, mass, and scale with surrounding Structures.

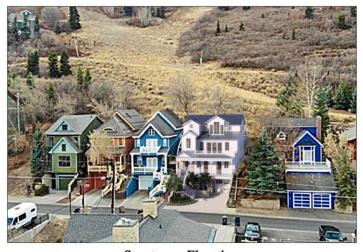

Streetscape Elevation

Figure 2: Proposed Streetscape

ACCESS – Access points and driveways must be designed to minimize Grading of the natural topography and to reduce overall Building scale. Side Access to garages is strongly encouraged, where feasible.

Complies – The proposed driveway is located in approximately the same spot as the existing driveway and will be 12 feet in width, 6 feet narrower than the existing driveway. The proposed driveway location has already been graded for the existing driveway and will not require further grading.

TERRACING – the project may include terraced retaining Structures if necessary to regain Natural Grade.

Complies – The Applicant has proposed some grading of the rear yard to provide an outdoor living space behind the home. The Existing Grade and Final Grade are similar except in the front yard where the Applicant has proposed a more gradual grade from the home to the street to mimic the grade of the Site before the current retaining walls were constructed.

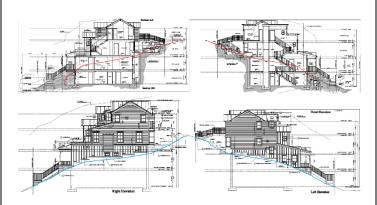


Figure 3: Existing Grade (red) and Final Grade (Blue)

The proposed Structure complies with the height requirements of the underlying HR-1 District as set forth in LMC §15-2.2-5. The proposed Structure is twenty five feet and five inches (25' 5") in height from Existing Grade and measures thirty five feet (35') from the lowest finish floor plane to the topmost wall plate.

BUILDING LOCATION -

Building, Access, and infrastructure must be located to minimize cut and fill that would alter the perceived natural topography of the Site. The Site design and Building Footprint must coordinate with adjacent properties to maximize opportunities for open Areas and preservation of natural vegetation, to minimize driveway and Parking Areas, and to provide variation of the front yard.

Complies – The proposed Structure will be sited in the same location as the existing SFD and will be two feet closer to the road than the existing wall. The proposed access to the Site will remain the same through a driveway connecting the garage to the Woodside Avenue public right-ofway.

BUILDING FORM AND SCALEWhere Building masses orient

Complies – The proposed SFD steps up as the hillside rises. The upper stories are stepped back

against the Lot's existing contours, the Structures must be stepped with the Grade and broken into a series of individual smaller components that are Compatible with the District. Low profile Buildings that orient with existing contours are strongly encouraged. The garage must be subordinate in design to the main Building. In order to decrease the perceived bulk of the Main Building, the Planning Director and/or Planning Commission may require a garage separate from the main Structure or no garage.

from the front to break up the visual impact of the Structure and to avoid a walled-in effect along the Streetscape.

SETBACKS – The Planning
Director may require an increase
in one or more Setbacks to
minimize the creation of a wall
effect along the Street front
and/or the rear lot line. The
Setback variation will be a
function of the Site constraints,
proposed Building scale, and
Setbacks on adjacent
Structures.

Complies – The proposed SFD is compliant with the required setbacks in the HR-1 Zoning District. The existing Structure projects further toward the street than the neighboring homes and the proposed SFD will be located 12 feet from the Front Lot Line. The existing Structure has a set of retaining walls that are built to the Front Lot Line to provide parking for the SFD. These walls will be removed and the proposed SFD will be constructed with a similar front setback as seen along the rest of the Streetscape.

DWELLING VOLUME – The maximum volume of any Structure is a function of the Lot size, Building Height, Setbacks, and provisions set forth in this Chapter. The Planning Director may further limit the volume of a proposed Structure to minimize its visual mass and/or to mitigate differences in scale between a proposed Structure and existing Structures.


Complies - The proposed SFD is comparable in height and massing with other Structures along the same block face. The upper levels of the SFD step back from the street to reduce the visual impact of the Structure from the Street, which is a common feature on neighboring buildings as well. A reduction in height is not necessary to mitigate differences in height or scale.

BUILDING HEIGHT | STEEP SLOPE – The HR-1 Zoning District Height is 27 feet. The

Complies – The proposed SFD is comparable in height and massing with other Structures along the same block face. The upper levels of the SFD step

Planning Director may require a reduction in Building Height for all or portions of a proposed Structure to minimize its visual mass and/or to mitigate differences in scale between a proposed Structure and the Historic character of the neighborhood's existing residential Structures.

back from the street to reduce the visual impact of the Structure from the Street, which is a common feature on neighboring buildings as well. A reduction in height is not necessary to mitigate differences in height or scale.

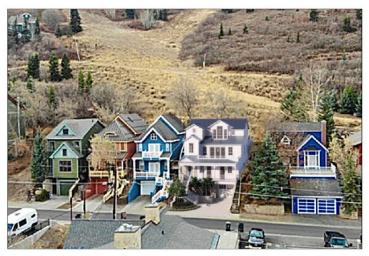

Streetscape Elevation

(II) Historic Residential (HR-1) Zoning District Requirements – LMC Chapter 15-2.2

Requirement	Analysis of Proposal
Lot Size:	Complies – The subject Lot is 37.5 feet in width and 75 feet in depth resulting in a Lot Area of 2,812.5
Minimum Lot Area for a	square feet.
Single-Family Dwelling is	
1,875 square feet.	
Lot Width:	Complies – the existing Lot is 37.5 feet in width measured 15 feet from the Front Lot Line.
Minimum Lot width is twenty-	
five feet (25') measured	
fifteen feet (15') from the	
Front Lot Line.	
Building Footprint:	Complies – The proposed footprint of the Structure is 1,165.5 square feet.
The maximum Building	
Footprint for a 37.5 x 75 foot	
lot is 1,201 square feet.	
Front Setback:	Complies – The Structure is set back approximately
	twelve feet (12') from the Front Lot Line. An
10 feet	uncovered staircase encroaches into the front

	setback by ten feet (10') and abuts the Front Lot Line. The stairs are no more than four feet (4') above Final Grade.
Rear Setback:	Complies with Condition of Approval #14 – The
real Scibaok.	proposed SFD is sited 16 feet from the Rear Lot
10 feet	Line. The Applicant has proposed the construction of a ski bridge connecting the top floor of the home to the slope of the open space abutting the property. Patios, decks, pathways, steps, or similar Structures
	may only be 30 inches above Final Grade and must be a minimum of 1 foot from the property line. The proposed ski bridge abuts the Rear Lot Line and is approximately 6 inches from the top of the rear
	1
	retaining wall. Staff recommends a condition of
	approval that the Applicant revise the design of the
	ski bridge to comply with LMC §15-2.2-3(H).
Side Setbacks:	Complies – The SFD is set back three feet from both side Lot Lines. The roof eaves encroach into the
3 feet each	setback by one foot on each side; an encroachment of two feet is permitted per LMC §15-2.2-3(J).
Building Height:	Complies – The proposed Structure is between nine
	feet two inches (9'2") and twenty five feet five inches
Maximum Building Height is	(25'5") from Existing Grade. The Structure is exactly
twenty-seven feet (27')	thirty five feet (35') in height from the lowest finish
above Existing Grade.	floor plane to the top of the topmost wall plate.
and the annual grounds	The second secon
A Structure shall have a	A ten-foot (10') deep horizontal step has been
maximum height of thirty five	included in the front (downhill) portion of the building.
feet (35') from the lowest	The ten-foot (10') horizontal step takes place at a
finish floor plane to the point	height of eighteen feet (18') from where the building
of the highest top wall plate	footprint meets the lowest point of Existing Grade.
that supports the ceiling joists or roof rafters.	The Contributing Roof Form of the proposed
	Structure has a 7:12 pitch.
A ten foot (10') minimum	
horizontal step in the	
downhill façade is required	
unless the First Story is	
located completely under the	
finish Grade on all sides of the Structure. The horizontal	
step shall take place at a	
maximum height of twenty	
three feet (23') from where	
the Building Footprint meets	
the lowest point of existing	

Grade.	
The roof pitch of a Structure's Contributing Roof	
Form shall be between 7:12 and 12:12.	

Notice

Staff published notice on the City's website and the Utah Public Notice website, and posted notice to the property on April 5, 2023. Staff mailed courtesy notice to property owners within 300 feet on April 5, 2023.

Public Input

Staff did not receive any public input at the time this report was published.

Alternatives

- The Planning Director may approve the Steep Slope Conditional Use Permit;
- The Planning Director may deny the Steep Slope Conditional Use Permit and direct staff to make Findings for the denial; or
- The Planning Director may request additional information and continue the discussion to a date certain/uncertain.

Exhibits

Exhibit A: Draft Final Action Letter

Exhibit B: Proposed Plans

Exhibit C: 475 Woodside Avenue Amended Plat



April 20, 2023

Ben and Holly Hoch 842 Emerald Bay Laguna Beach, CA 92651 949-752-6345

CC: Richard Krantz

NOTICE OF PLANNING DIRECTOR ACTION

Description

Address: 475 Woodside Avenue

Zoning District: Historic Residential (HR-1) District

Application: Steep Slope Conditional Use Permit (SSCUP)

Project Number: PL-23-05585 (SSCUP)

Action: APPROVED WITH CONDITIONS (See Below)

Date of Final Action: Thursday April 20, 2023

Project Summary: Applicant seeks to demolish an existing Single-Family

Dwelling and construct a new Single-Family Dwelling on a Steep Slope within the Historic Residential (HR-1) District.

Action Taken

On April 20, 2023, the Planning director conducted a public hearing and approved the Steep Slope Conditional Use Permit to demolish an existing Single-Family Dwelling and construct a new Single-Family Dwelling on a Steep Slope within the Historic Residential (HR-1) District at 475 Woodside Avenue according to the following findings of fact, conclusions of law, and conditions of approval.

Findings of Fact

- 1. The Site is located at 475 Woodside Avenue.
- 2. The Site is Lot 1 in the 475 Woodside Avenue Amended Plat, recorded at the Summit County Recorder's Office on July 7, 1999 (Entry #543463).
- 3. The Site is located within the Historic Residential (HR-1) District.



- 4. There is an existing Single-Family Dwelling on the Lot and the Applicant proposes to demolish it and construct a new Single-Family Dwelling.
- 5. The existing Single-Family Dwelling was constructed in 1966 and is not listed on the Historic Sites Inventory (HSI).
- 6. The required setbacks are 10 feet in the front, 10 feet in the rear and 3 feet in the sides.
- 7. The proposed structure is compliant with the HR-1 District setbacks; it is 12 feet from the Front Lot Line, 16 feet from the Rear Lot Line, and 3 feet from both Side Lot Lines.
- 8. The allowable maximum building footprint in the HR-1 District on a Lot of this size is 1,201 square feet.
- 9. The proposed building footprint is 1,165.5 square feet.
- 10. The allowable maximum building height in the HR-1 District is 27 feet.
- 11. The proposed Structure is 25 feet 5 inches in height.
- 12. LMC §15-3-6(A) requires two Off-Street parking spaces for SFDs.
- 13. The proposed Structure includes two Off-Street parking spaces within a tandem garage.
- 14. The maximum driveway width permitted per LMC §15-3-8(B)(1)(h) is twelve feet (12').
- 15. The proposed driveway is eleven feet and seven inches (11' 7") in width.
- 16. Garages in SFDs must have a minimum interior dimension of eleven feet (11') wide by twenty feet (20') deep per LMC §15-3-4(A)(1).
- 17. The proposed garage has an interior dimension of eleven feet (11') by thirty-six feet (36').
- 18. Staff reviewed the 475 Woodside Avenue Steep Slope Conditional Use Permit for compliance with LMC Chapter 15-2.2 Historic Residential Zoning District.
- 19. The proposed Structure complies with the underlying requirements of the HR-1 District (LMC Chapter 15-2.2), including the Steep Slope Conditional Use Permit requirements.
- 20. On April 5, 2023, City staff provided a public hearing notice to all property owners within 300 feet of the proposed SSCUP and posted a sign to the subject property.
- 21. On April 5, 2023, City staff published a public hearing notice to the City website and to the Utah Public Notice website.

Conclusions of Law



 The proposal complies with the LMC requirements pursuant to LMC Chapter 15-2.2 Historic Residential (HR-1) District, including the standards for Development on Steep Slopes.

Conditions of Approval

- Final building plans and construction details shall be the same as the plans approved April 20, 2023 by the Planning Department. Any changes, modifications, or deviations from the approved design that have not been approved in advance by the Planning and Building Departments may result in a stop work order.
- 2. If the Applicant does not obtain a complete building permit within one year of the date of this approval, this approval will expire unless the Applicant submits a written extension request to the Planning Department prior to the expiration date and the Planning Department approves an extension.
- 3. The Applicant is responsible for notifying the Planning Department prior to making any changes to the approved plans.
- 4. Any changes, modifications, or deviations from the approved scope of work shall be submitted in writing for review and approval/denial in accordance with the applicable standards by the Planning Director or designee prior to construction.
- The property is located outside of the Park City Landscaping and Maintenance of Soil Cover Ordinance (Soils Ordinance) and therefore not regulated by the City for mine-related impacts. If the property owner does encounter mine waste or mine waste impacted soils they must handle the material in accordance with State and Federal law.
- Any exterior wood shall have an opaque rather than transparent finish. When
 possible, low-VOC (volatile organic compound) paints and finishes shall be used.
 Rustic, unfinished wood is inappropriate.
- 7. All proposed mechanical equipment and/or hot tubs shall meet all setback requirements per LMC §15-2.2-3 and shall be screened with no hot tubs on front façade decks. If the equipment is located on a secondary façade, it shall be placed behind the midpoint of the structure or in a location that is not visible from the primary public right-of-way along Woodside Avenue. Ground-level equipment shall be screened using landscape elements such as low fences, low stone walls, or perennial plant materials.
- 8. Any areas disturbed during construction surrounding the proposed work shall be brought back to its original state.
- 9. Construction shall not impact surrounding historic structures.



- 10. Vinyl or aluminum doors and windows are prohibited.
- 11. Metal materials shall not be reflective.
- 12. All exterior lighting shall be down directed, fully shielded, and 3,000 degrees Kelvin or less to prevent glare onto adjacent property and public rights-of-way and shall comply with the City's outdoor lighting code per LMC §15-5-5(J). Final lighting details must be reviewed by Planning Staff prior to installation.
- 13. The Applicant shall calculate the caliper of the existing mature trees on the Site and replace them with an equivalent (or greater) caliper of tree(s) as required in LMC §15-13-8(B)(1)(c).
- 14. The Applicant shall revise the design of the proposed ski bridge in the rear of the Site to comply with LMC §15-2.2-3(H). If the bridge cannot be designed to comply with the LMC requirements it shall be removed from the plans.

If you have questions or concerns regarding this Final Action Letter, please call (435)-615-5063 or email caitlyn.tubbs@parkcity.org.

Sincerely,

Gretchen Milliken, Planning Director

CC: Caitlyn Tubbs, Sr. Historic Preservation Planner

LEGAL DESCRIPTION

LOT 1, 475 WOODSIDE AVENUE AMENDMENT A.P.N.: 475-1

Hoch Residence

475 Woodside Avenue Park City, UT 84060



VICINITY MAP



REVISION LOG

EV.	DATE	REASON
	•	

The services to be performed by the Architect/Engineer pursuant to this Agreement with the Owner are intended solely for the benefit of the Owner, and no benefit is conferred hereby, nor is any contractual relationship established herewith, upon or with any person or entity not a party to this Agreement. No such person or entity shall be entitled to rely on the Architect/Engineer's performance of its services hereunder, and no right to assert a claim against the Architect/Engineer, its officers, employees, agents, or consultants shall accrue to the Contractor or to any subcontractor, sub-subcontractor, independently retained professional consultant, applier, fabricator, manufacturer, lender, tenant, insurer, surety, or any other third party as a result of this Agreement or the performance or non-performance of the Architect/Engineer's services hereunder.

NOTE:

IT IS THE CONTRACTOR'S RESPONSIBILITY TO ENSURE THAT ALL HEAVY COSMETIC ARCHITECTURAL ELEMENTS HAVE STRUCTURAL SUPPORT DESIGNED BY A LICENSED STRUCTURAL ENGINEER. HEAVY COSMETIC ELEMENTS ARE THOSE ELEMENTS WHICH HAVE NOT BEEN ACCOUNTED FOR ON THE STRUCTURAL PLANS IN THIS SET. THESE MAY INCLUDE, BUT ARE NOT LIMITED TO, DECORATIVE BEAMS, FIREPLACE SURROUNDS, INTERIOR WALL AND CEILING MASONRY OR STONEWORK AND CHANDELIERS.

INDEX

STREETSCAPE ELEVATION AND PROPOSED ESTATE 3-D IMAGES

CURRENT PHOTOGRAPHS EXHIBIT DESIGN REFERENCE IMAGES

ARCHITECTURAL SITE PLAN

GARAGE AND MAIN LEVEL FLOOR PLANS MID AND UPPER LEVEL FLOOR PLANS

ROOF PLAN

BUILDING SECTIONS

EXTERIOR ELEVATIONS EXTERIOR ELEVATIONS ARCHITECTURAL DETAILS

BUILDING SECTIONS

LANDSCAPE SHEETS BY ARCSITIO DESIGN, INC.

GRADING PLAN LANDSCAPE PLAN

CIVIL PLANS BY FERRARI SURVEYING, LLC

RECORD OF SURVEY AND TOPOGRAPHICAL MAP

PROJECT DATA

OWNER

BEN AND HOLLY HOCH 842 EMERALD BAY LAGUNA BEACH, CA 92651 PH (949) 697-1560

SCOPE OF WORK

DEMOLISH EXISTING RESIDENCE AND CONSTRUCT A NEW 4-STORY SINGLE-FAMILY RESIDENCE WITH ATTACHED GARAGE.

475 WOODSIDE AVENUE PARK CITY, UT 84060 PROJECT ADDRESS:

OCCUPANCY: R3 / U

CONSTRUCTION TYPE: VB, (SPRINKLERED)

BUILDING CODES:

SQUARE FOOTAGE

TOTAL CONDITIONED AREA:

CONDITIONED AREA: GARAGE LEVEL: MAIN LEVEL: MID LEVEL: UPPER LEVEL: 663 SQ. FT. 1,002 SQ. FT. 857 SQ. FT. 578 SQ. FT.

UNCONDITIONED AREA:

GARAGE LEVEL PATIO: FRONT PORCH: MID DECK: 3,100 SQ. FT.

207 SQ. FT. 167 SQ. FT. 218 SQ. FT. TOTAL DECKS & PATIOS 592 SQ. FT.

401 SQ. FT.

PLAN CHECK/ PERMIT FILE NUMBERS

GRADING PLAN:	MECHANICAL:
HOUSE PLANS:	PLUMBING:
RETAINING WALLS:	ELECTRICAL:

CONSULTANTS

THE OWNER OF THIS PROJECT HAS RETAINED THE CONSULTANTS BELOW TO PROVIDE DESIGN SERVICES IN THE INDIVIDUAL DISCIPLINES AS LISTED. ALL OF THE REPORTS, DRAWINGS OR CALCULATIONS OF THESE CONSULTANTS ARE NECESSARY FOR THE PROPER CONSTRUCTION OF THIS PROJECT. AS A CONDITION OF THE USE OF THESE PLANS, THE CONTRACTOR IS REQUIRED TO BE FAMILIAR WITH, AND TO MAINTAIN CURRENT COPIES OF THESE CONSULTANTS' DOCUMENTS ON THE JOB SITE.

LANDSCAPE ARCHITECT

ARCSITIO DESIGN, INC. 1058 EAST 2100 SOUTH SALT LAKE CITY, UT 84106

CONTACT: STEVEN GILBERT

(801) 487-4923 SGILBERT@ARCSITIODESIGN.COM

INTERIOR DESIGNER

CC & COMPANY DESIGNS 200 BRIGGS AVENUE COSTA MESA, CA 92626

CONTACT: COURTNEY ZIETHING

(949) 650-4222 CC&COMPANYDESIGNS@GMAIL.COM

Avenue 84060

esidence

Hoch

DRAWN

CHECKED

2/3/2023 REVISION

SET NO.

SHEET NO.

Architecture

Richard

Sheet


over









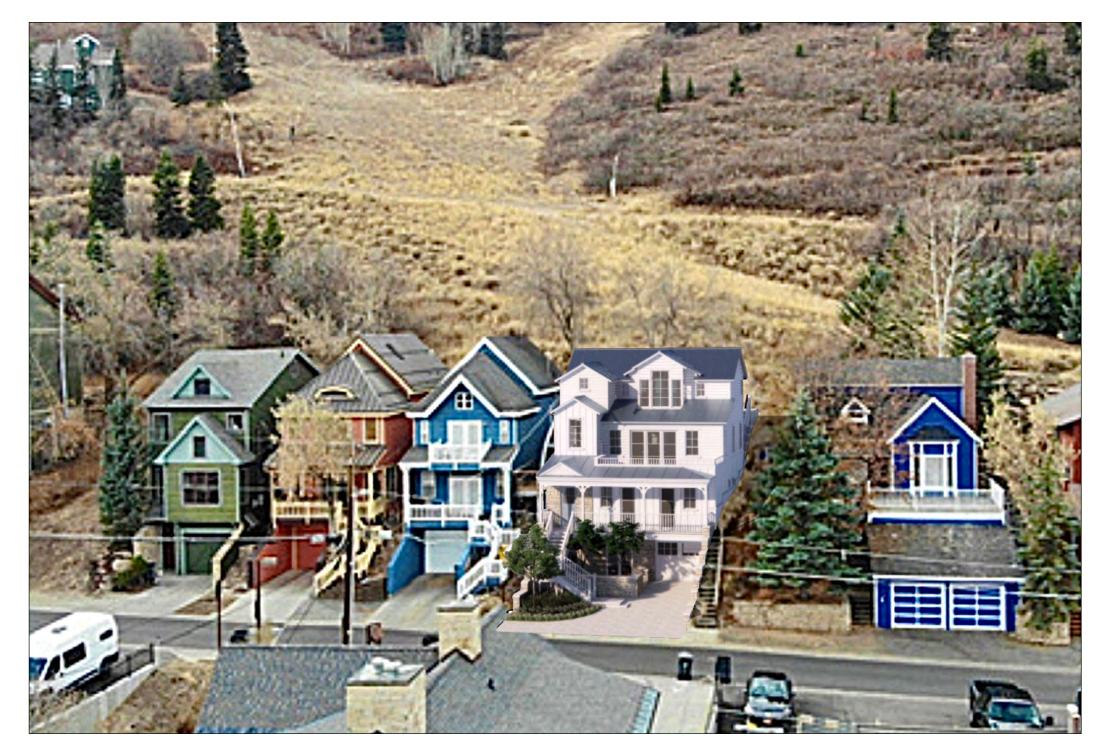



Streetscape Elevation







Proposed Estate 3D image

NOTICE: THIS DRAWING HAS BEEN PUBLISHED AND IS THE SOLE PROPERTY OF RICH, ARCHITECTURE, INC., AND IS LENT TO THE BORROWER FOR HIS CONFIDENTIA

th Residence
Woodside Avenue
City, UT 84060

DRAWN

CHECKED

DATE

2/3/2023

REVISION

A0.1















Rear View (Facing Toward Site)




Front View - Facing away from Site






Left Side View (Facing away from Site)

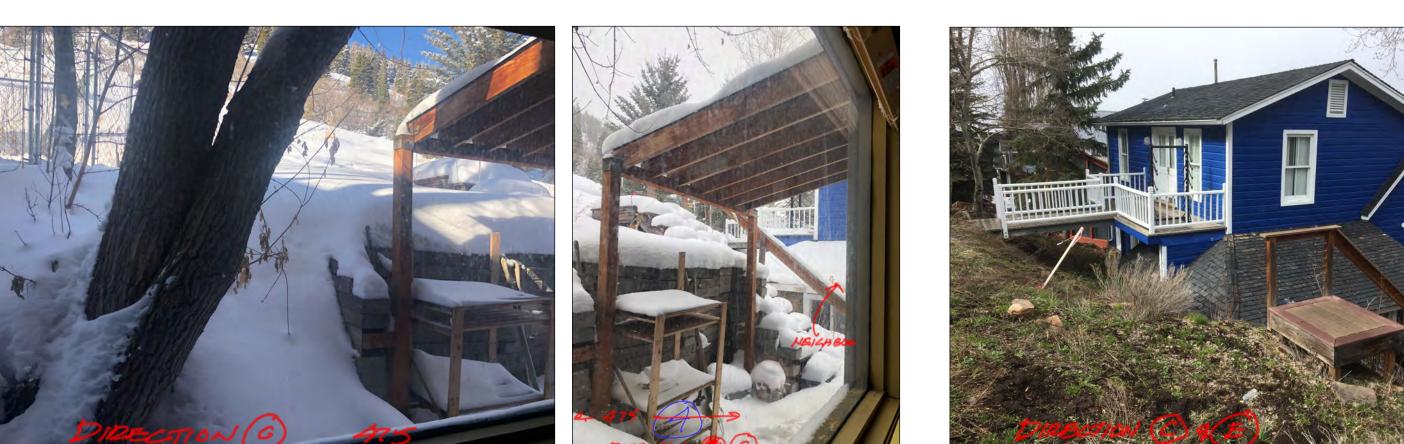


Rear View (Facing away from Site)




Right Side View (Facing away from Site)

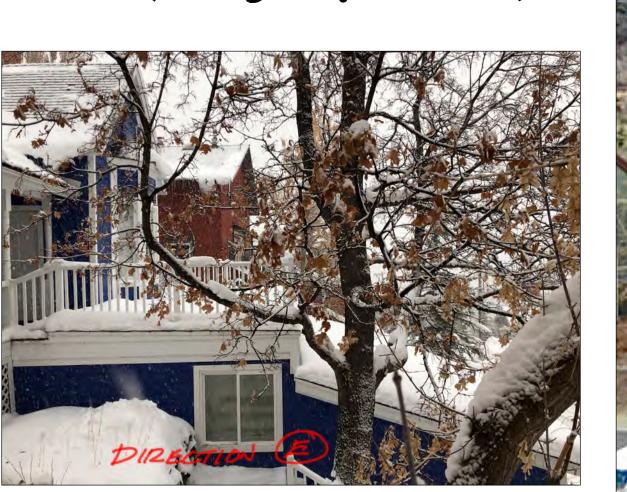

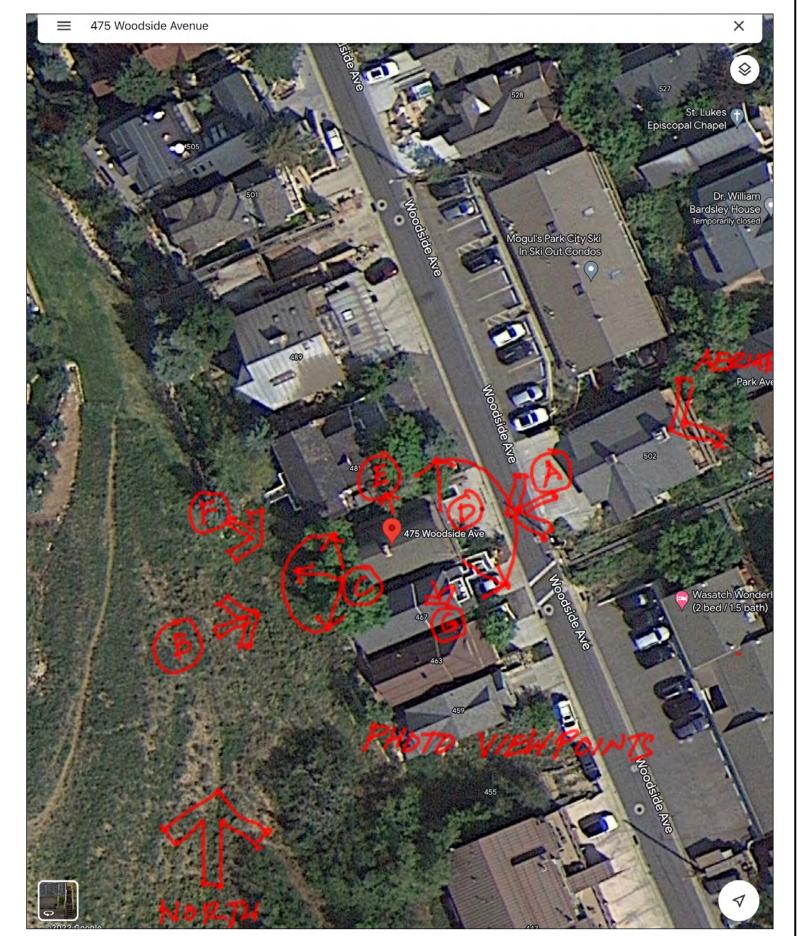

Aerial View

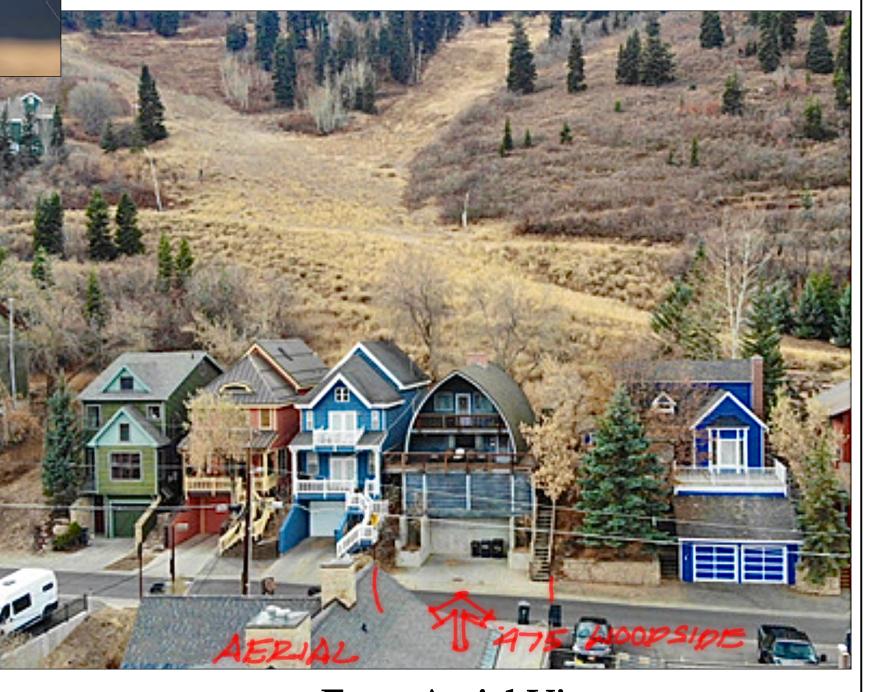


Front Aerial View

Hoch Residence


DATE 7/13/2022





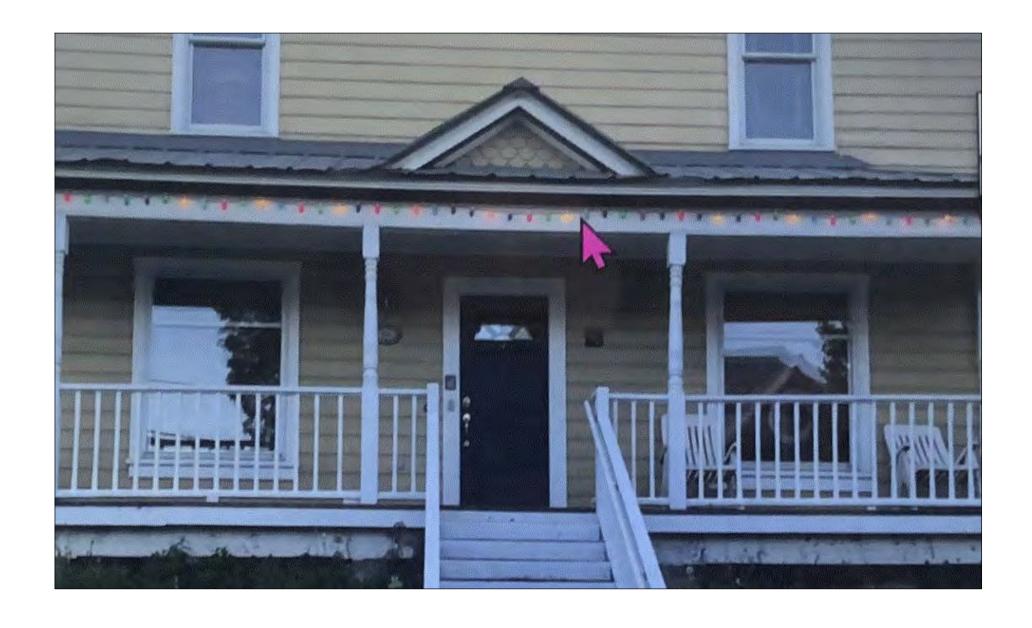



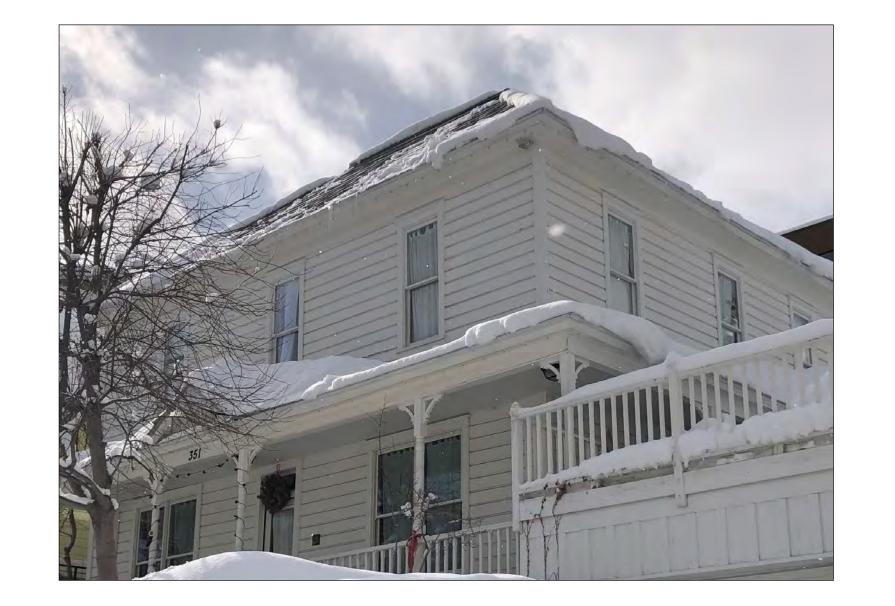



Design Reference Images

Hoch Residence

CHECKED

D A T E
7/12/2022
R E V I S I O N


SET NO.


SHEET NO.

Richard Krantz Architecture, Inc.

Architecture / Planning
1500 Quail Street, Suite 520
Newport Beach, CA 92660
(949) 752-6345 Fax (949) 752-6235

475 Woodside Avenue Park City, UT 84060

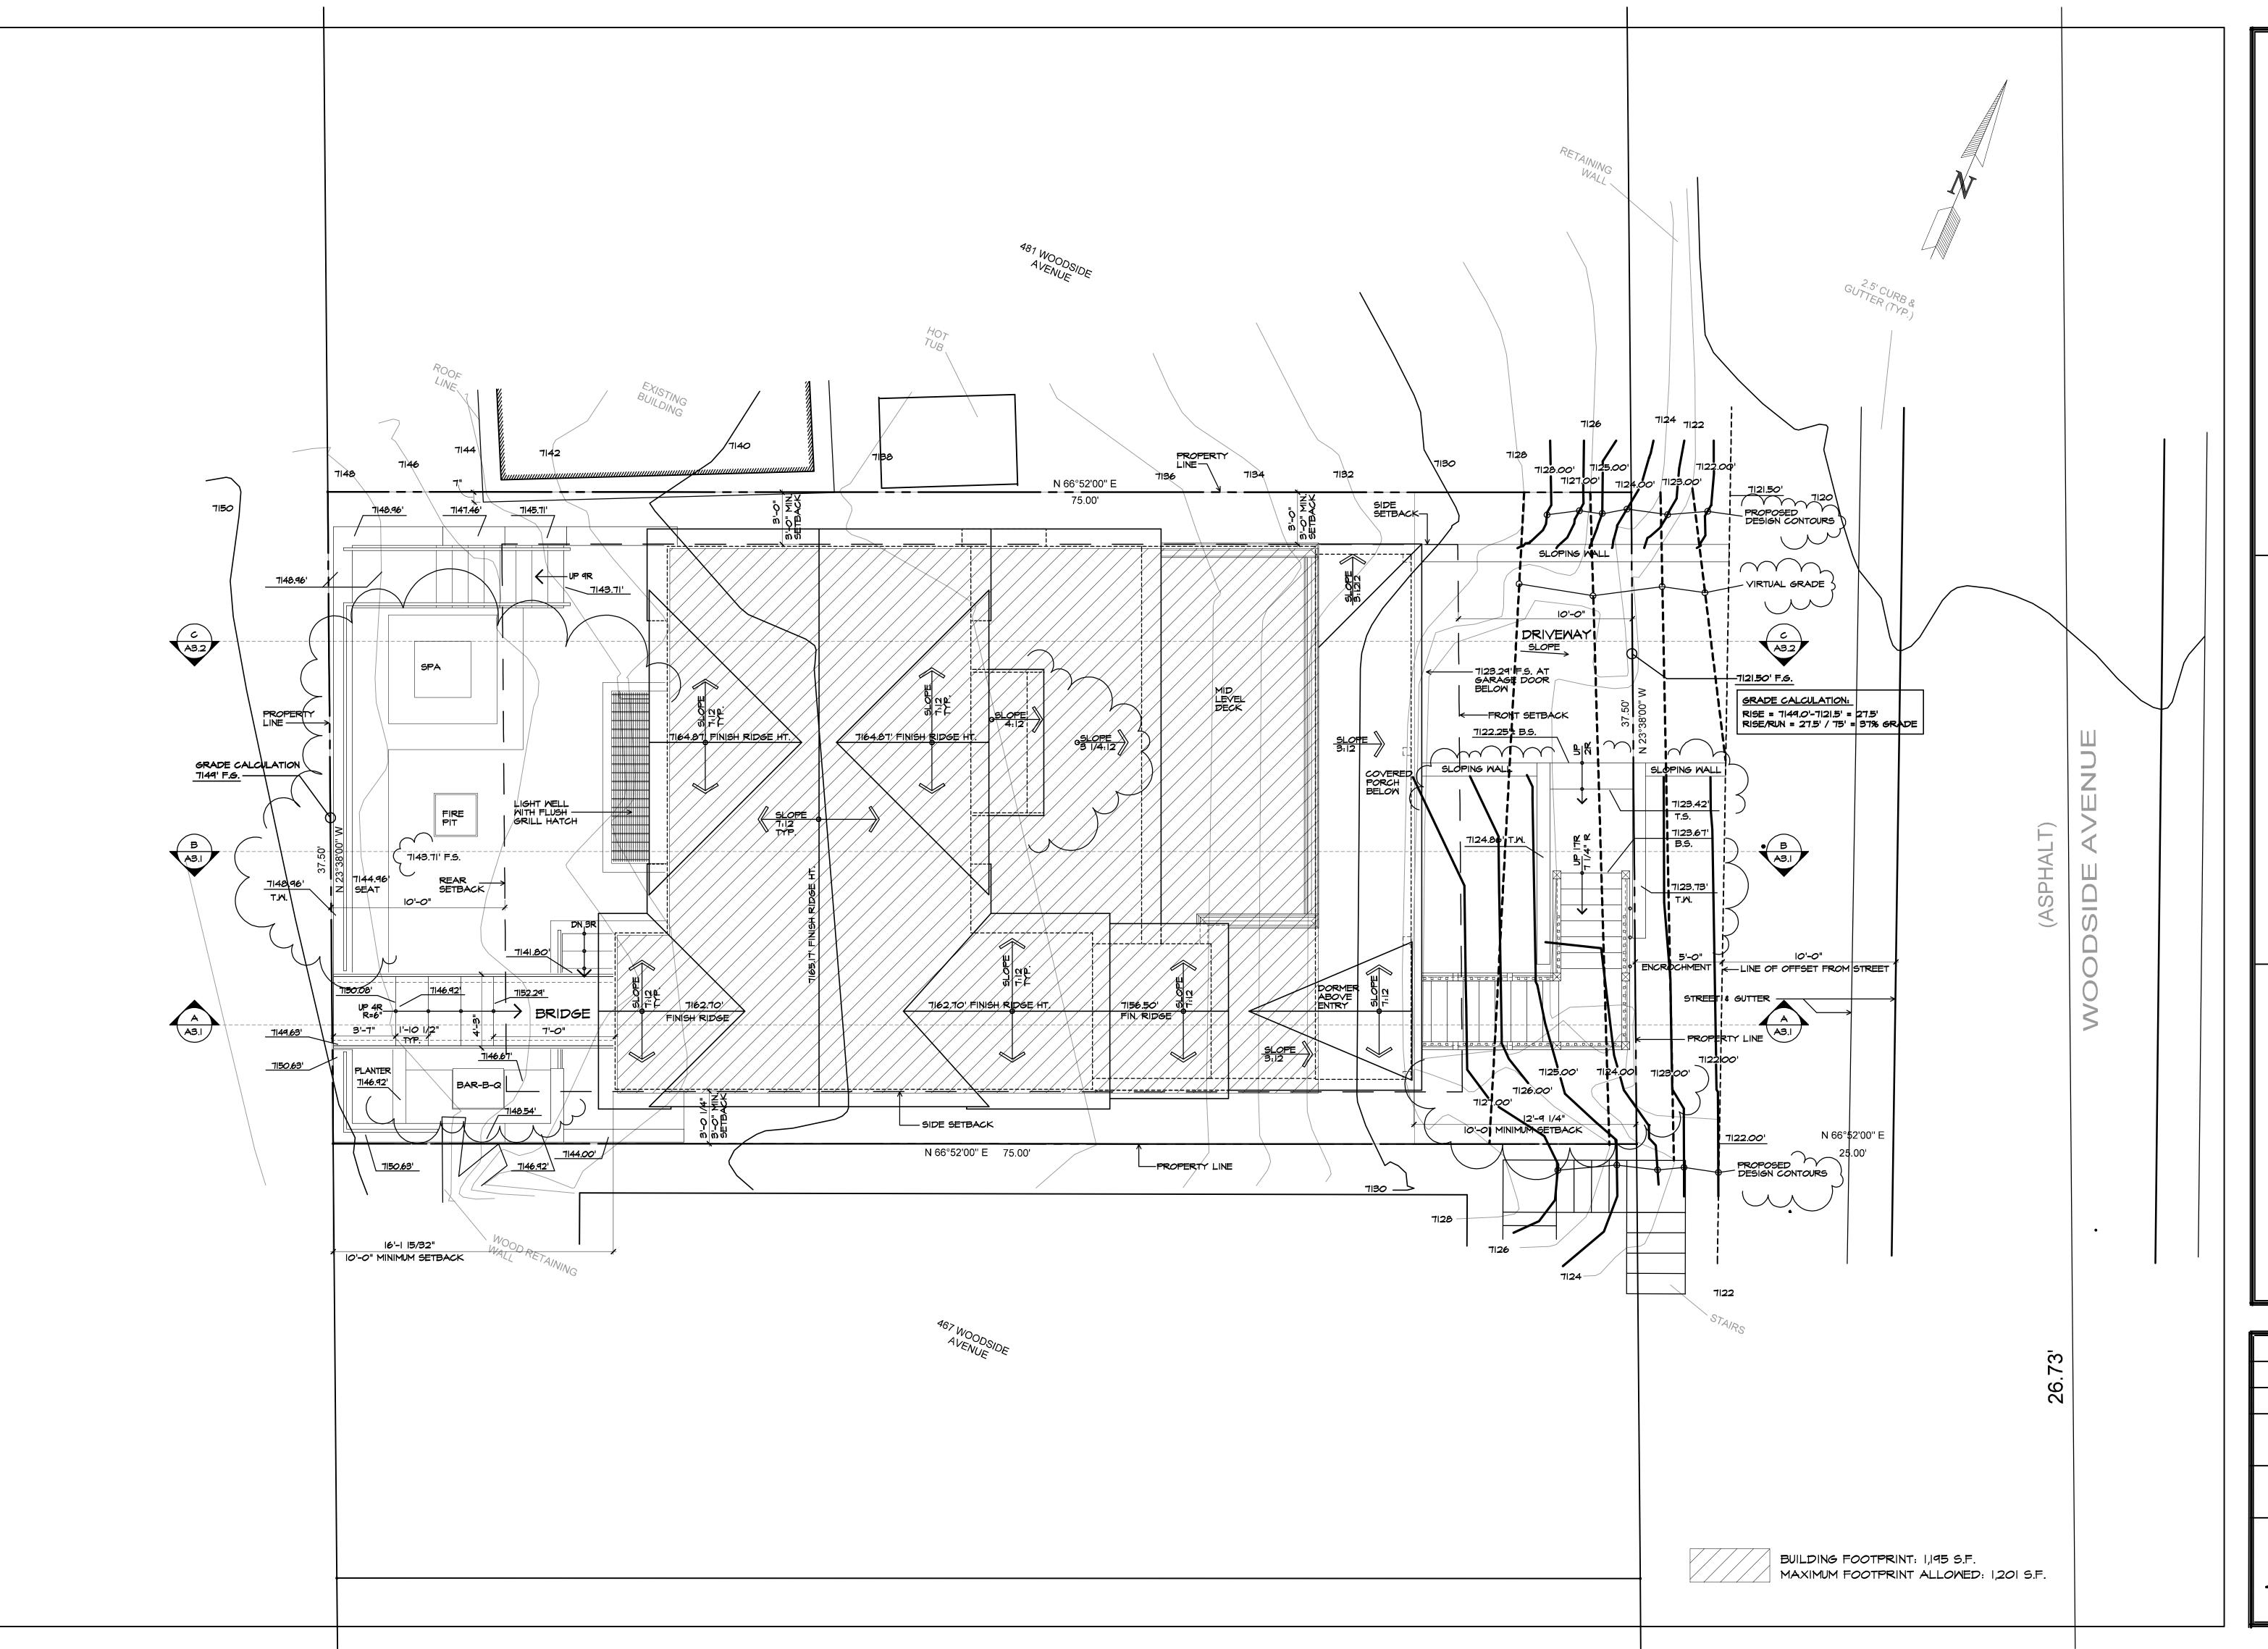


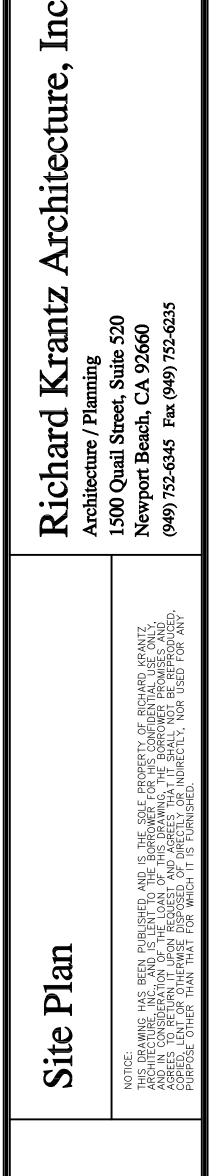

DRAWN AE
CHECKED , R.K.
DATE 2/2/2023
REVISION
SCALE
/4" = '-0"
SHEET NO.

475 Woodside Avenue Park City, UT 84060

Hoch Residence

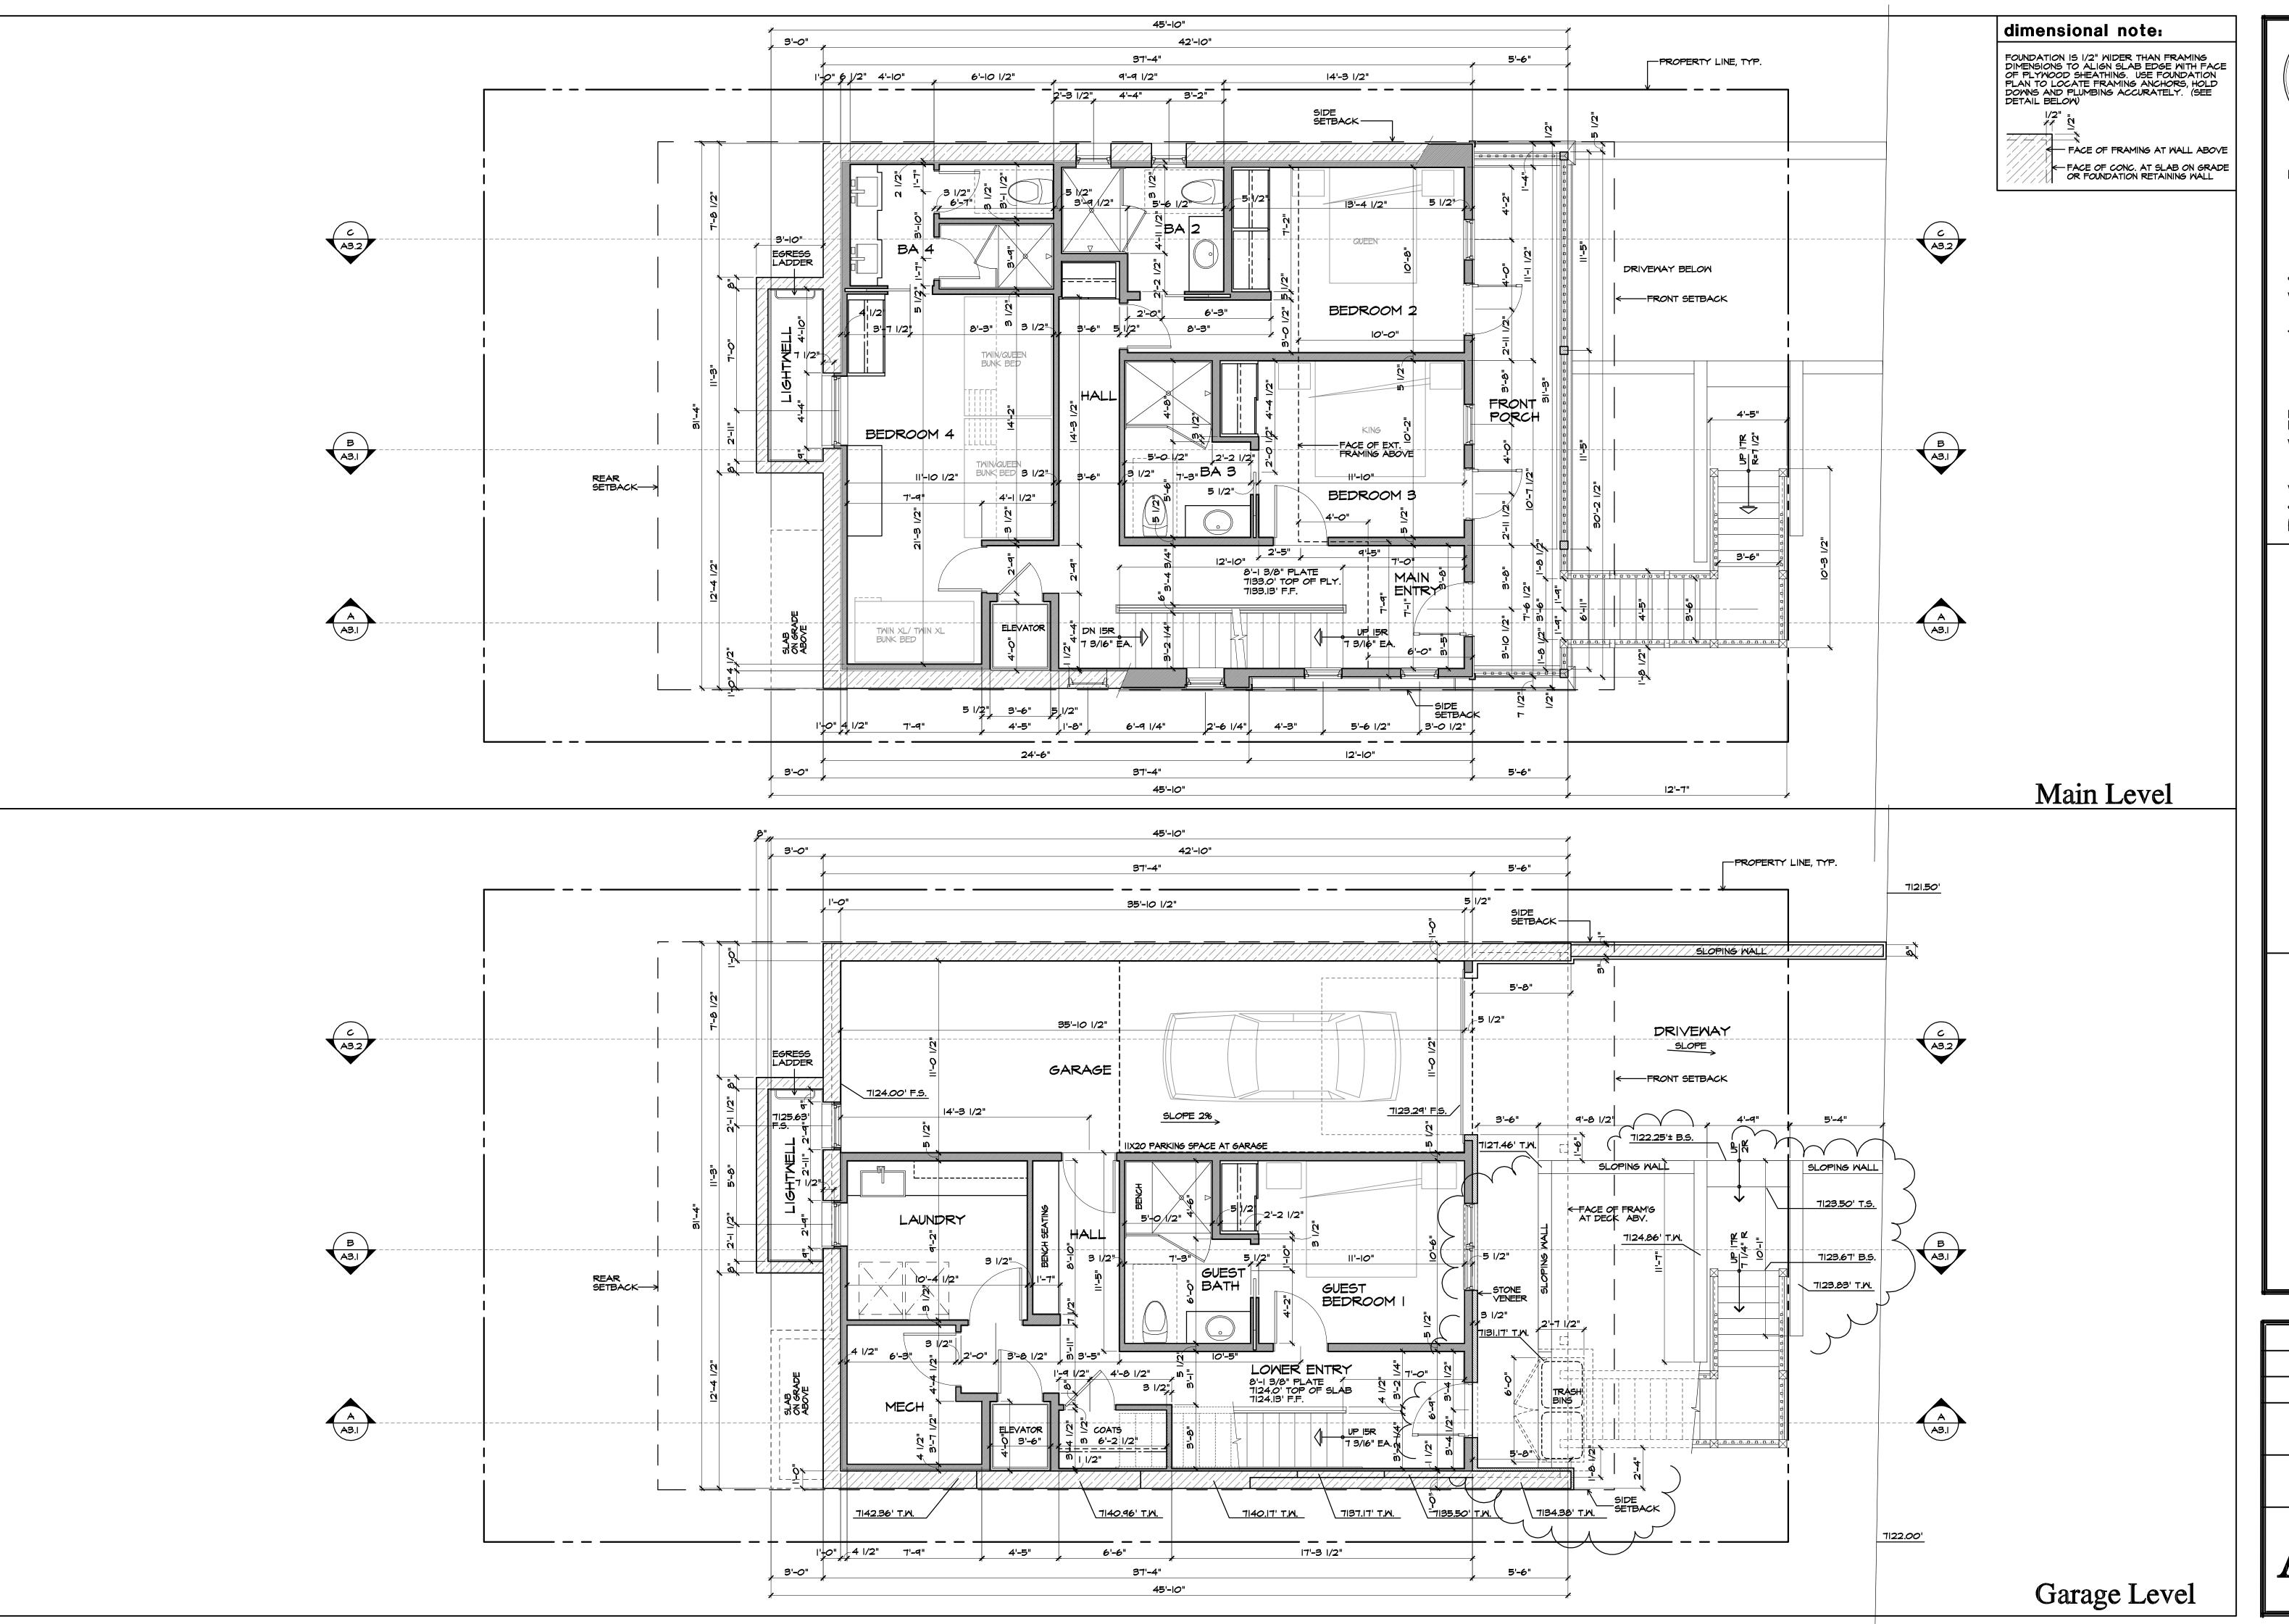

Richard Krantz Architecture

Architecture / Planning

1500 Quail Street, Suite 520
Newport Beach, CA 92660

Floor Plans (Garage and Main

Hoch Residence 475 Woodside Avenue Park City, UT 84060


DRAWN
AE
CHECKED
R.K.

DATE
2/2/2023
REVISION

SCALE
1/4" = 1'-0"

SHEET NO.

A2.1

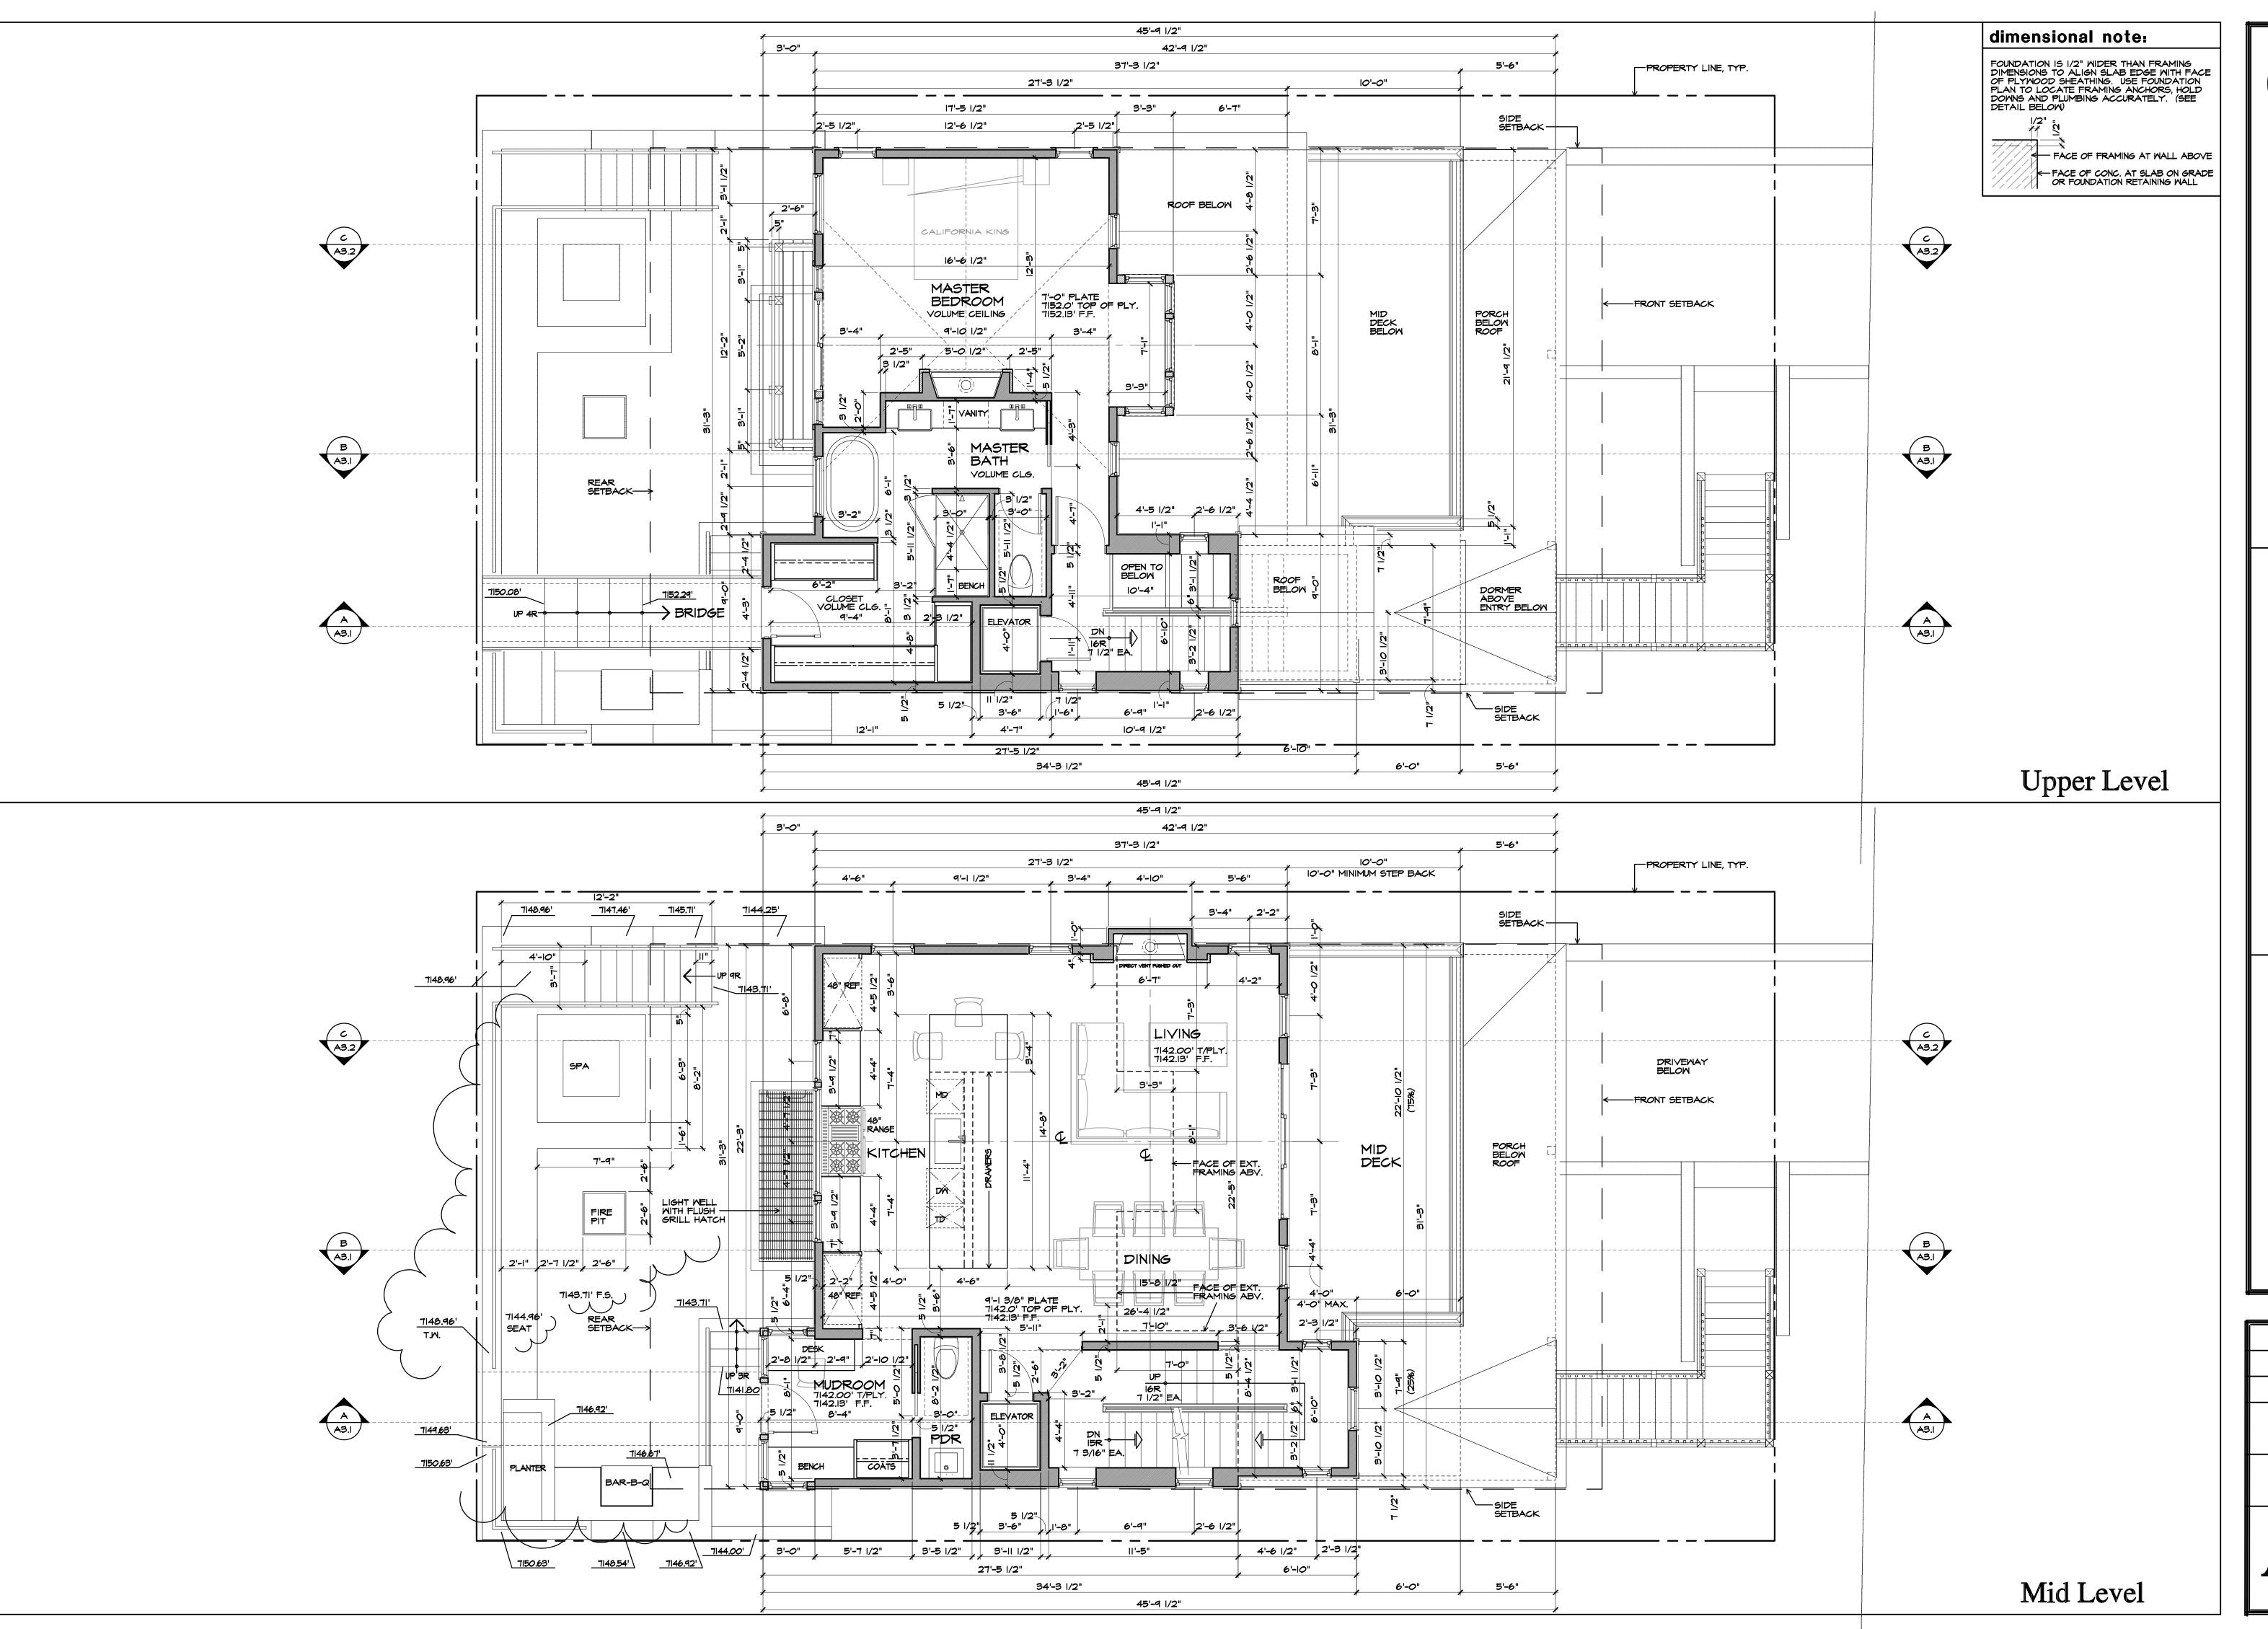

DC. COUNTY OF WATER OF WITH THE OF WITH TH

Richard Krantz Architecture

Architecture / Planning

1500 Quail Street, Suite 520

Newport Beach, CA 92660

Floor Plans (Mid and Upper)


Hoch Residence 475 Woodside Avenue Park City, UT 84060

DRAWN
AE
CHECKED
R.K.

DATE
2/2/2023
REVISION

SCALE
1/4" = 1'-0"

SHEET NO.

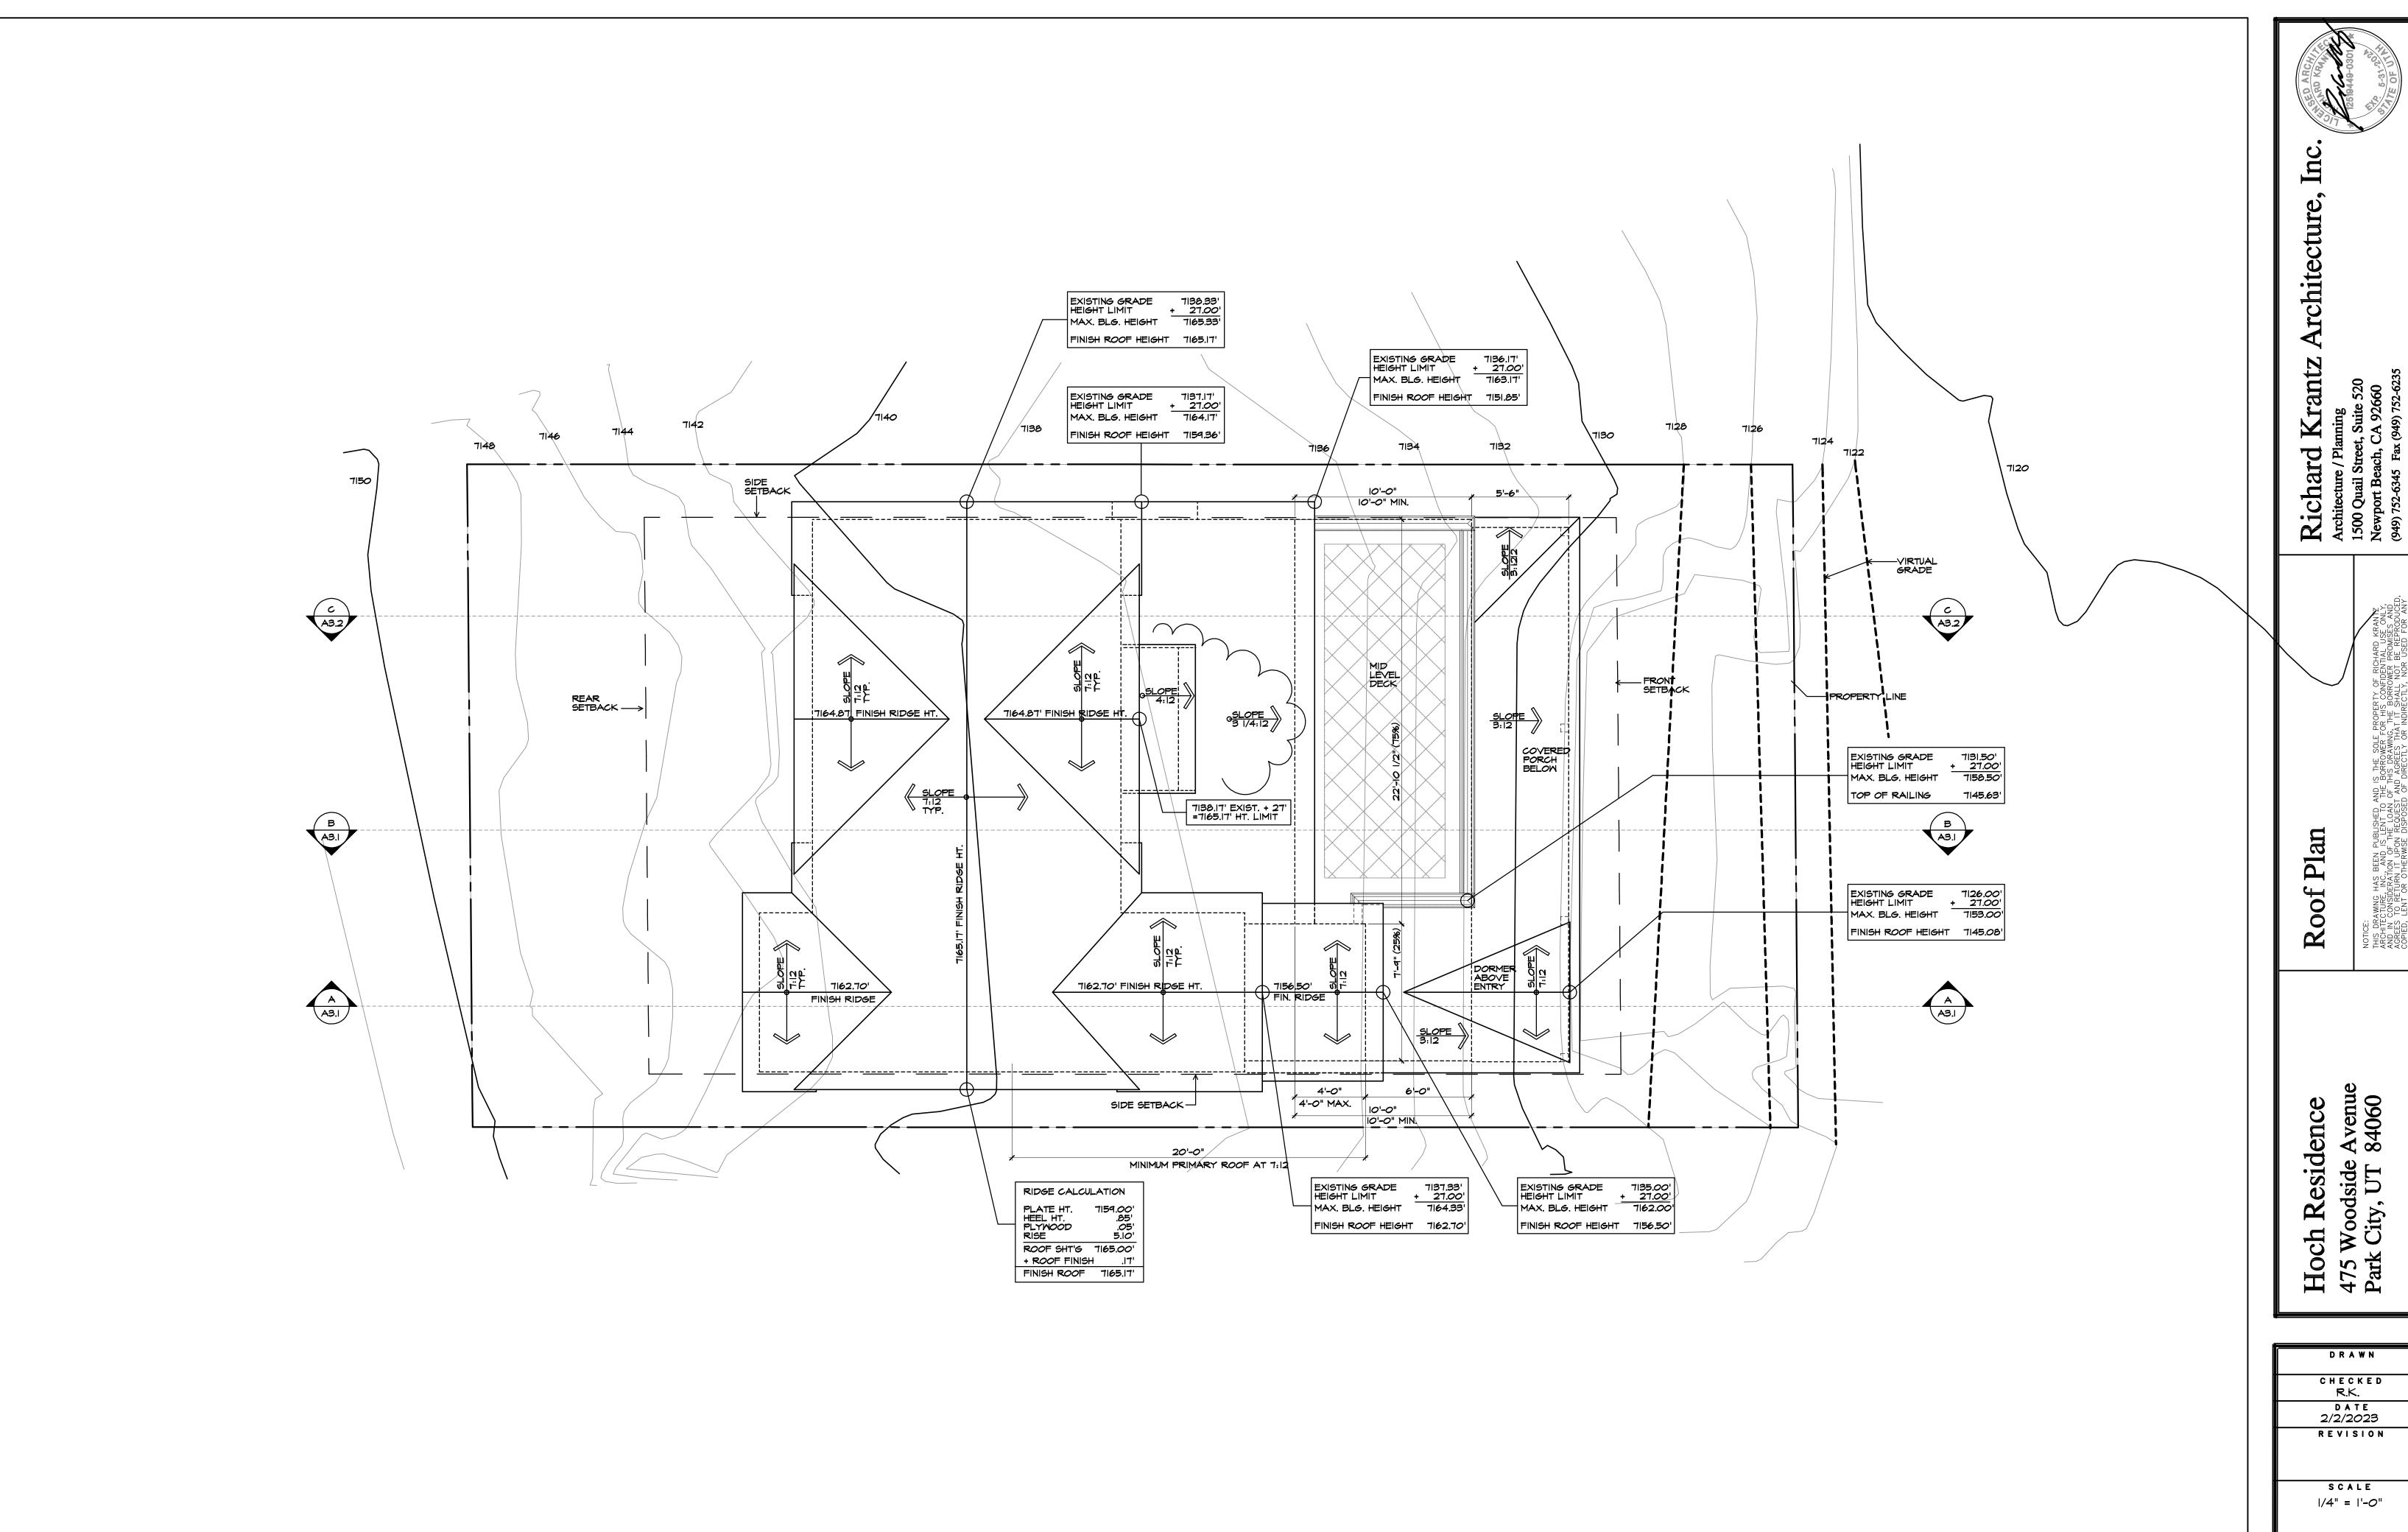


Roof P


Hoch Residence 475 Woodside Avenue Park City, UT 84060

DRAWN CHECKED R.K. D A T E 2/2/2023 REVISION

SCALE 1/4" = 1'-0"

SHEET NO.

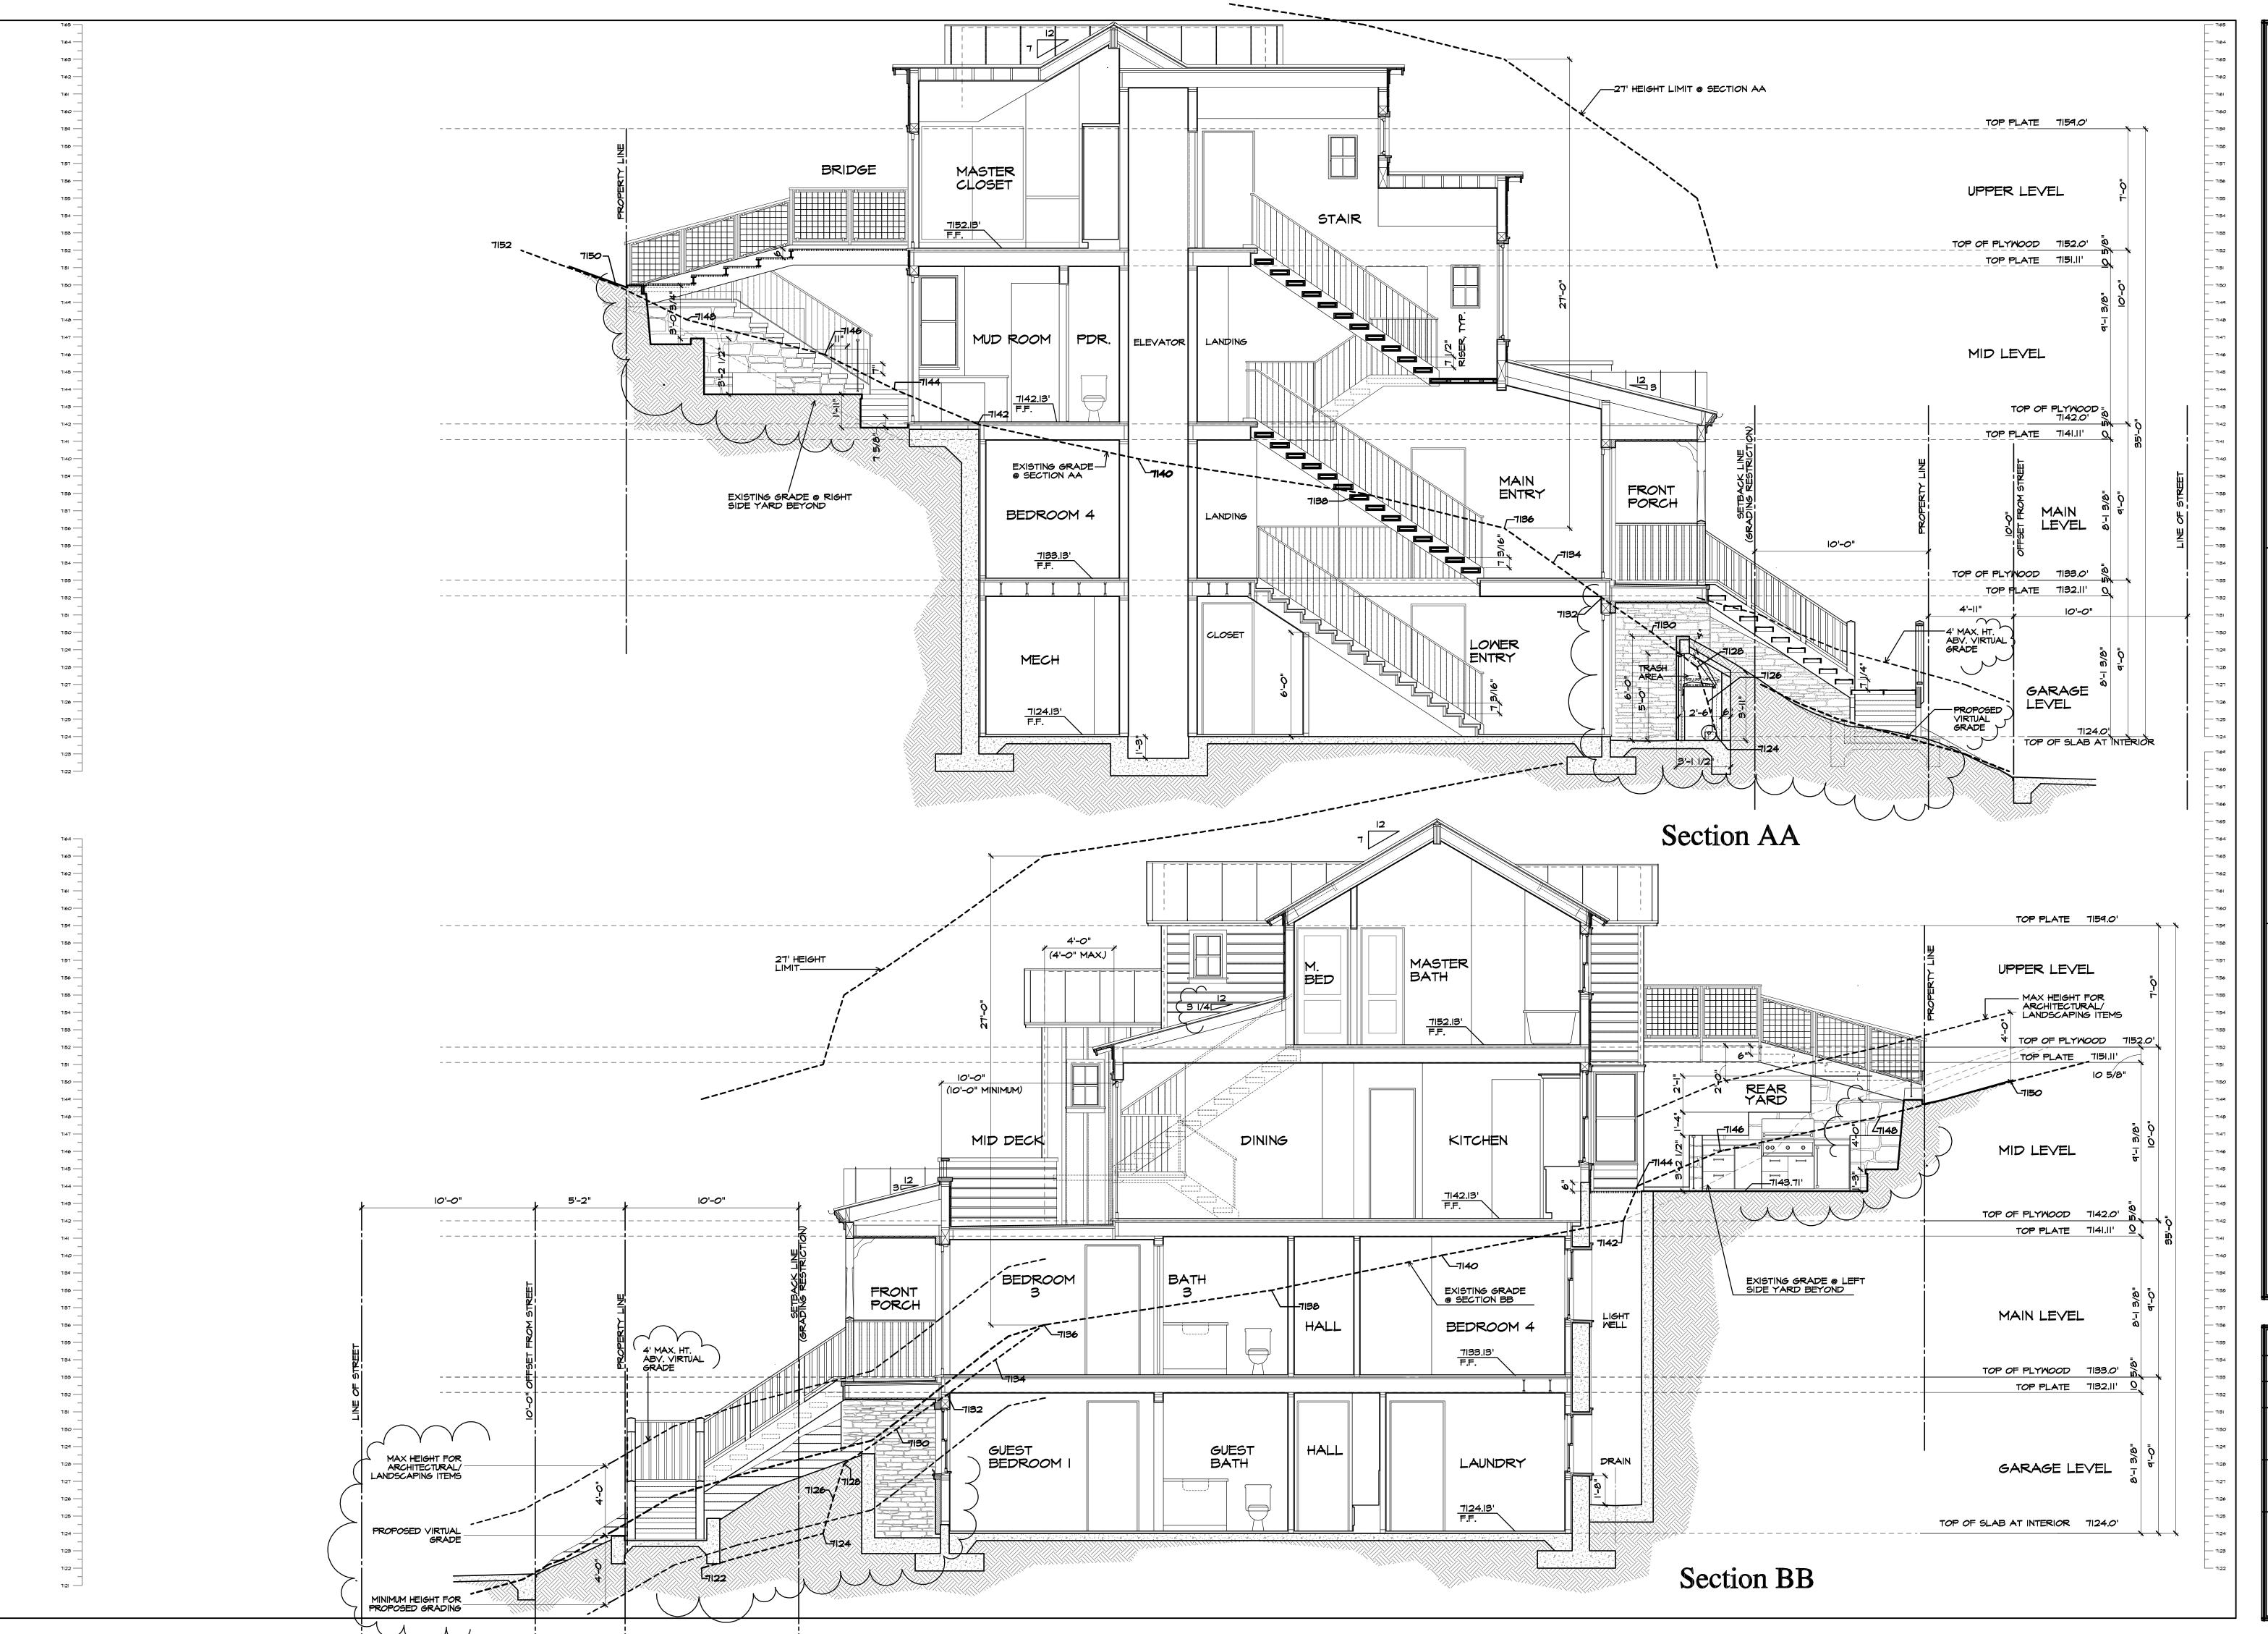

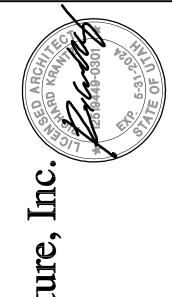

Richard Krantz Architecture,

Architecture / Planning
1500 Quail Street, Suite 520

Building Sections


Hoch Residence 475 Woodside Avenue Park City, UT 84060

DRAWN
AE
CHECKED
R.K.
DATE
2/2/2023
REVISION

SCALE
1/4" = 1'-0"

SHEET NO.

43.1

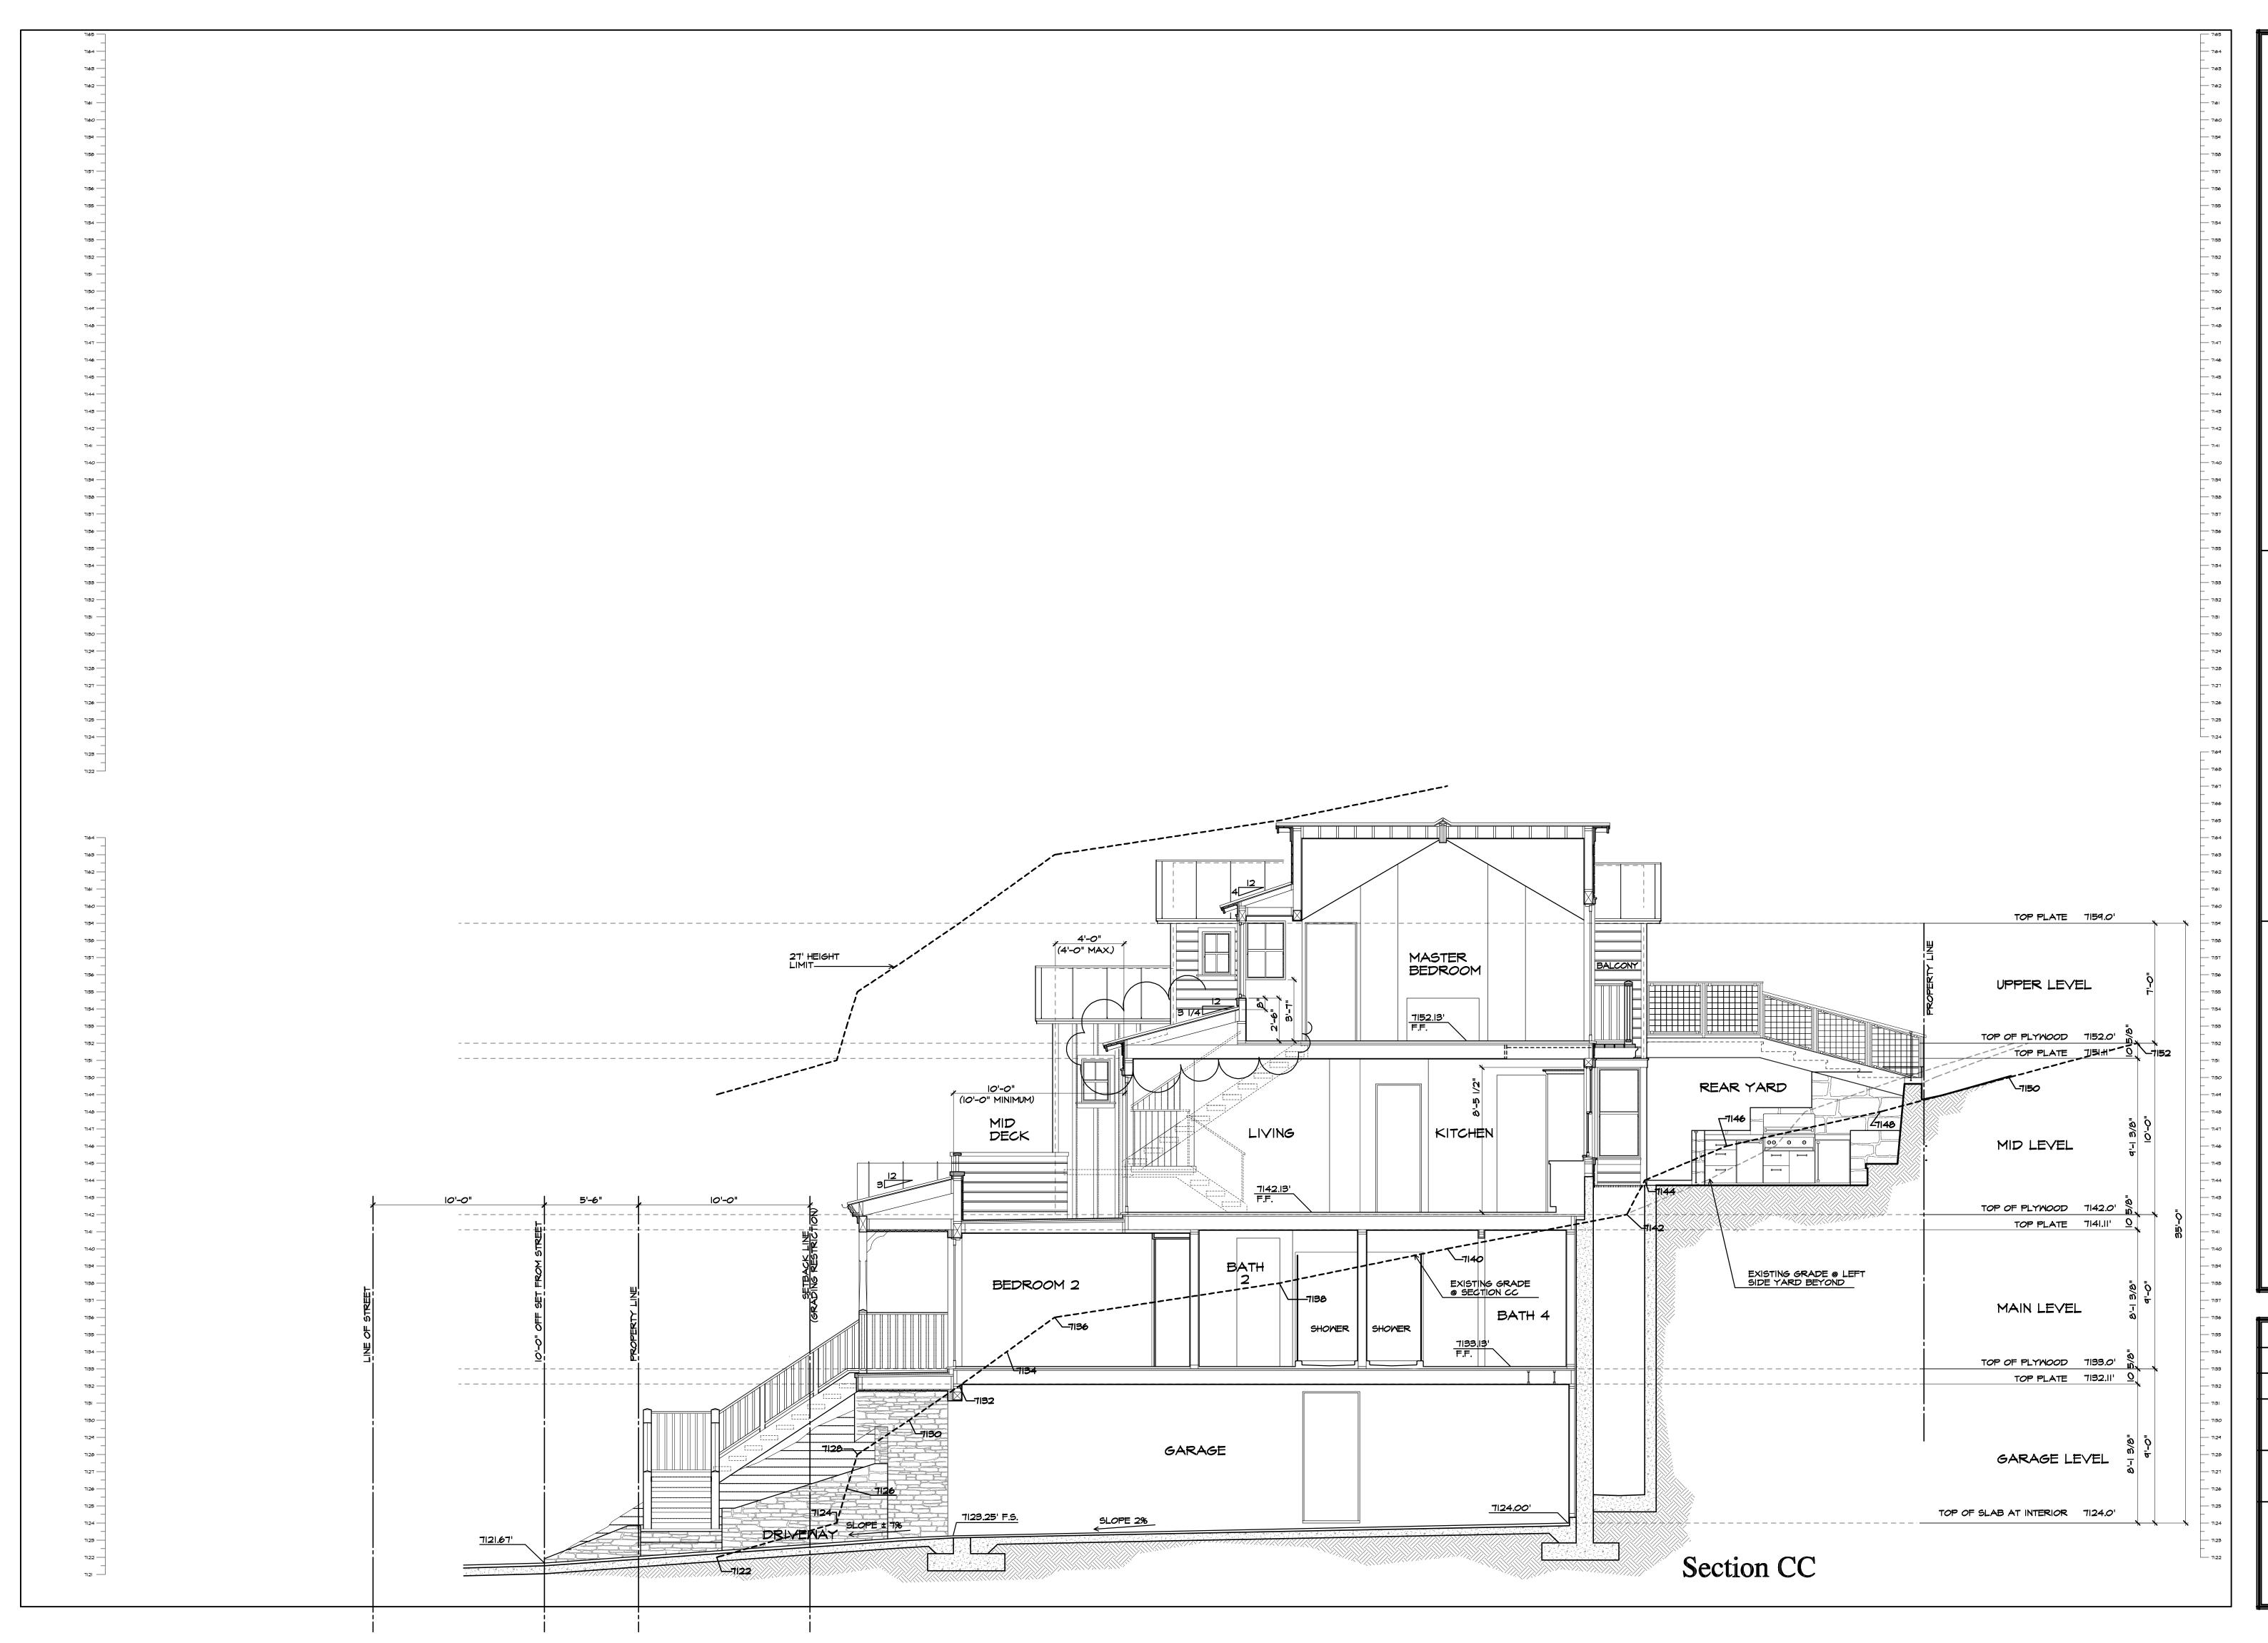



Richard Krantz Archite

Architecture / Planning
1500 Quail Street, Suite 520


Building Sections

Hoch Residence 475 Woodside Avenue Park City, UT 84060

DRAWN
AE
CHECKED
R.K.
DATE
2/2/2023
REVISION

SCALE
1/4" = 1'-0"
SHEET NO.

13.2

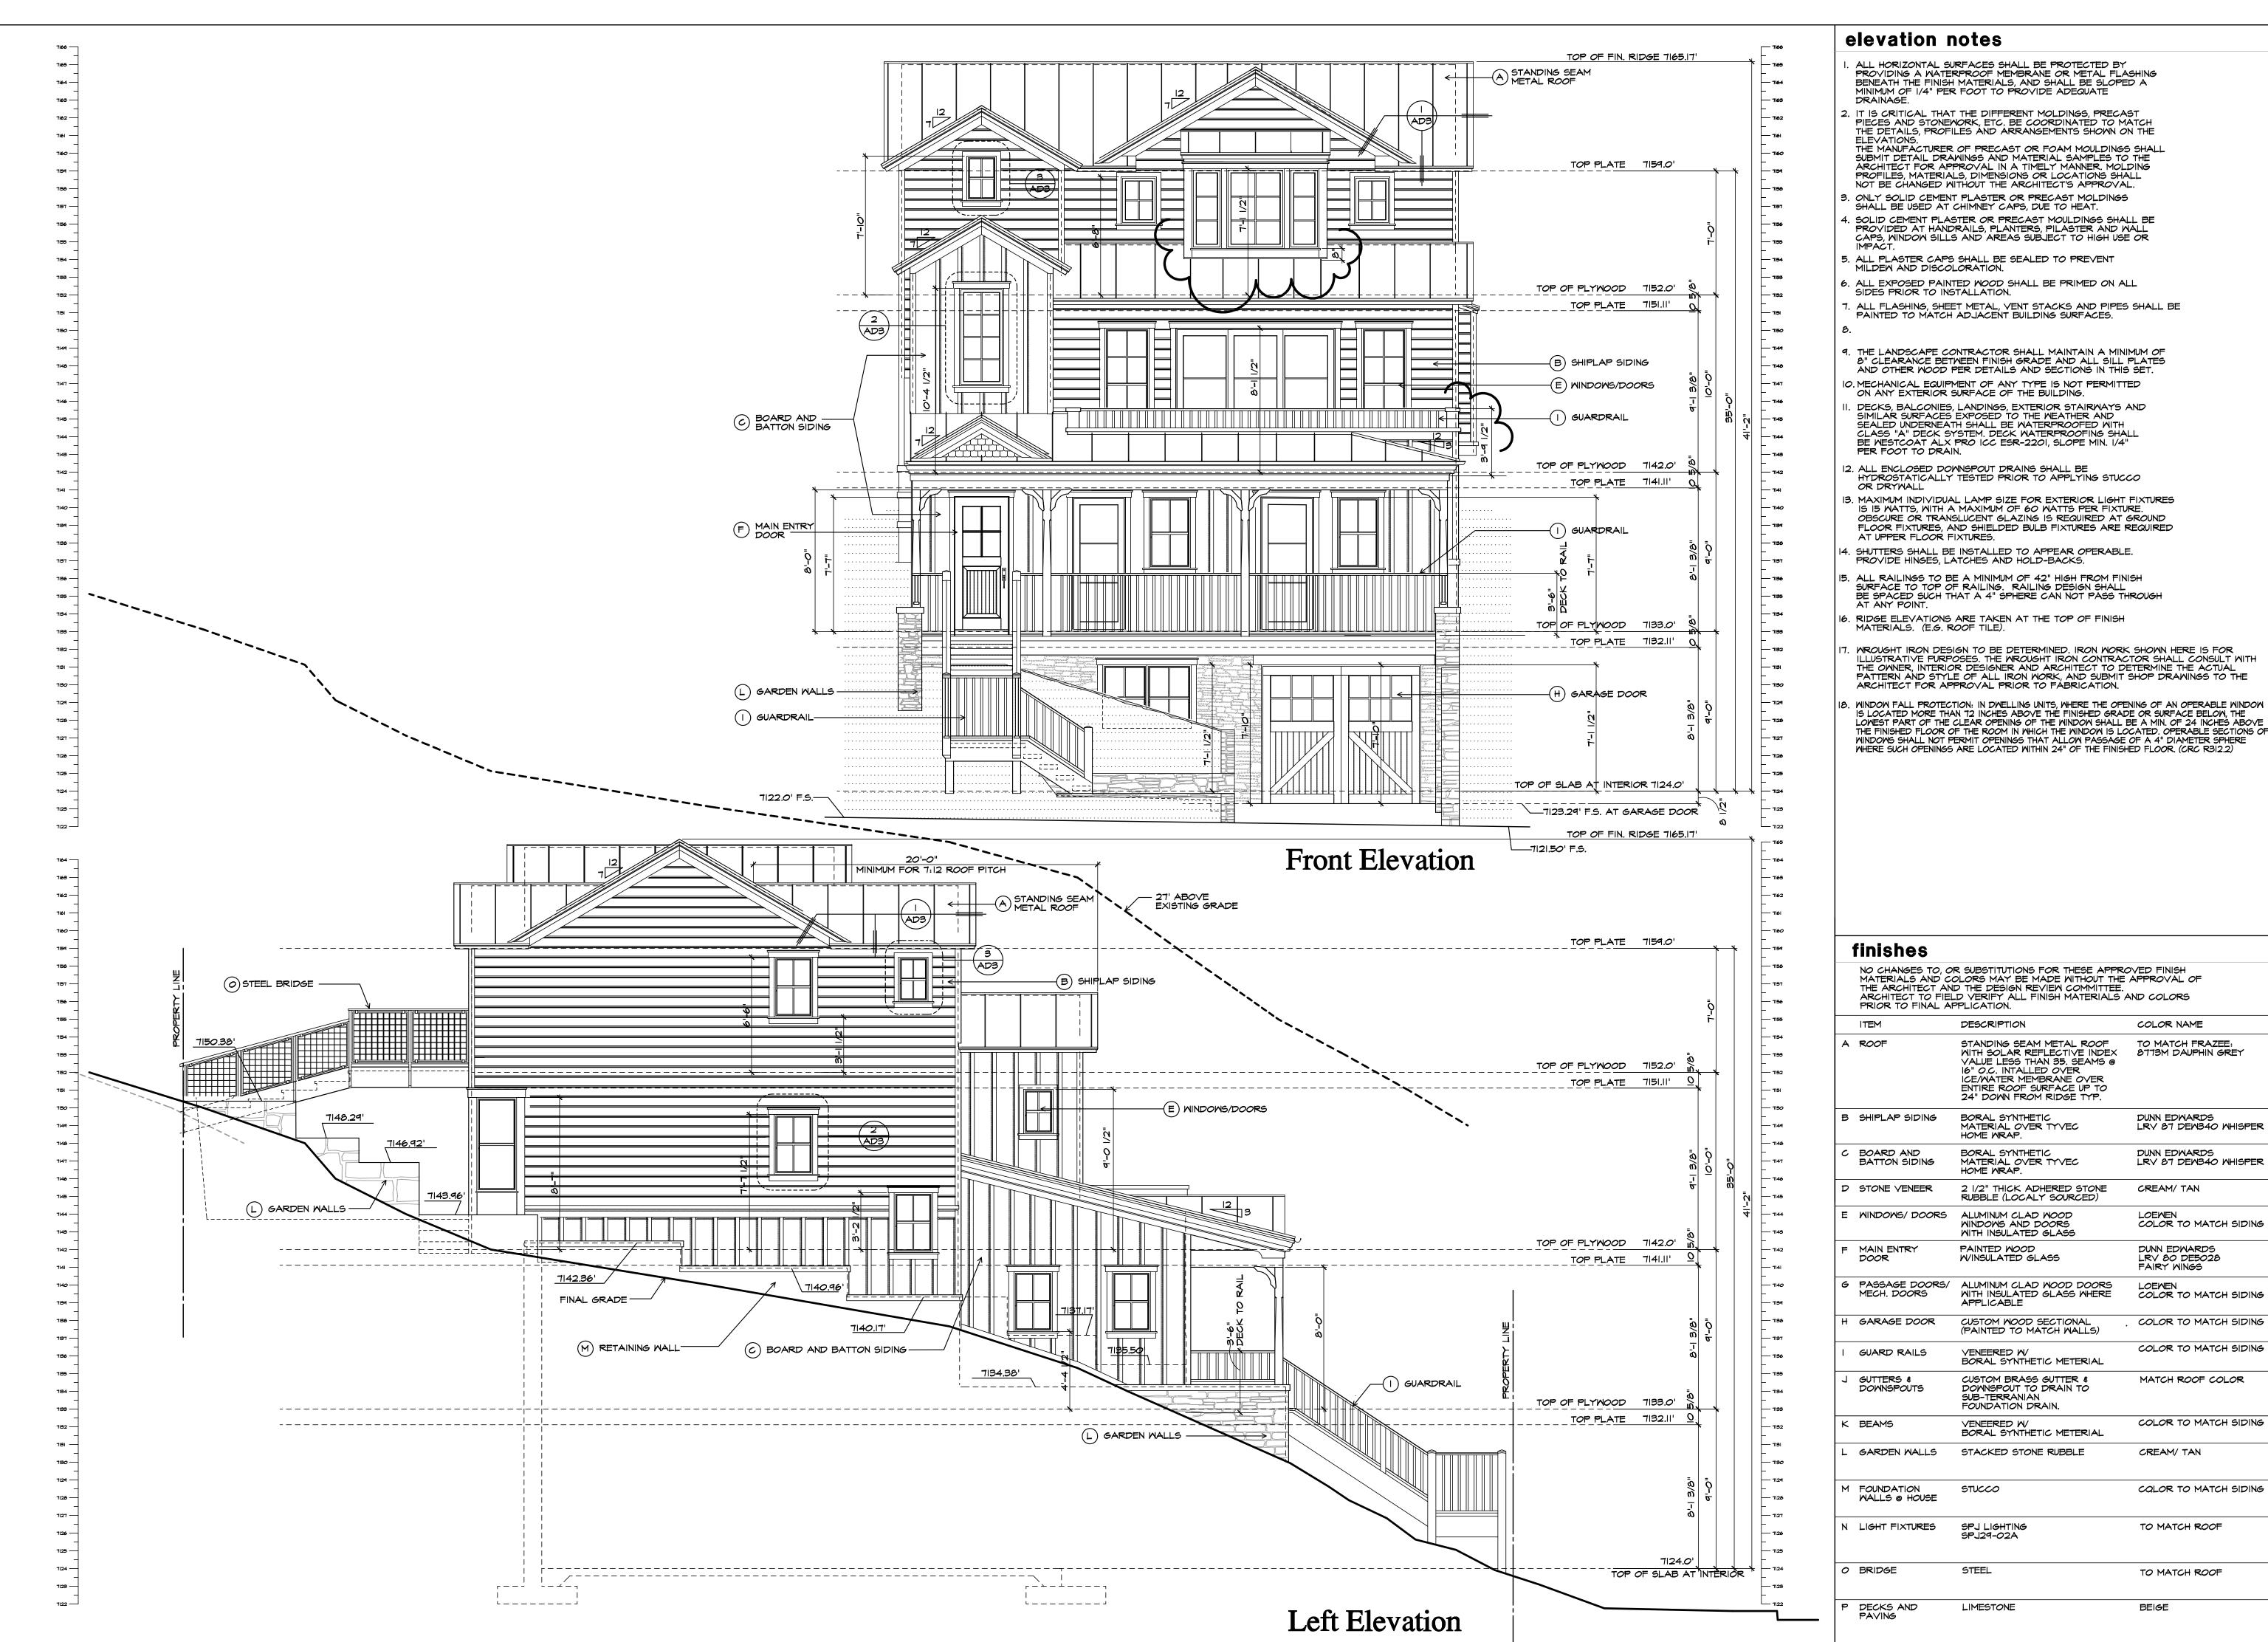



ch

ation E Or

COLOR NAME

TO MATCH FRAZEE:

DUNN EDWARDS

DUNN EDWARDS

CREAM/ TAN

DUNN EDWARDS LRV 80 DE5028 FAIRY WINGS

8773M DAUPHIN GREY

LRV 87 DEM340 WHISPER

LRY 87 DEW340 WHISPER

COLOR TO MATCH SIDING

CREAM/ TAN

TO MATCH ROOF


TO MATCH ROOF

BEIGE

MATCH ROOF COLOR

Avenue 84060 sid

DRAWN CHECKED R.K. DATE 2/3/2023 REVISION SCALE 1/4" = 1'-0" SHEET NO.

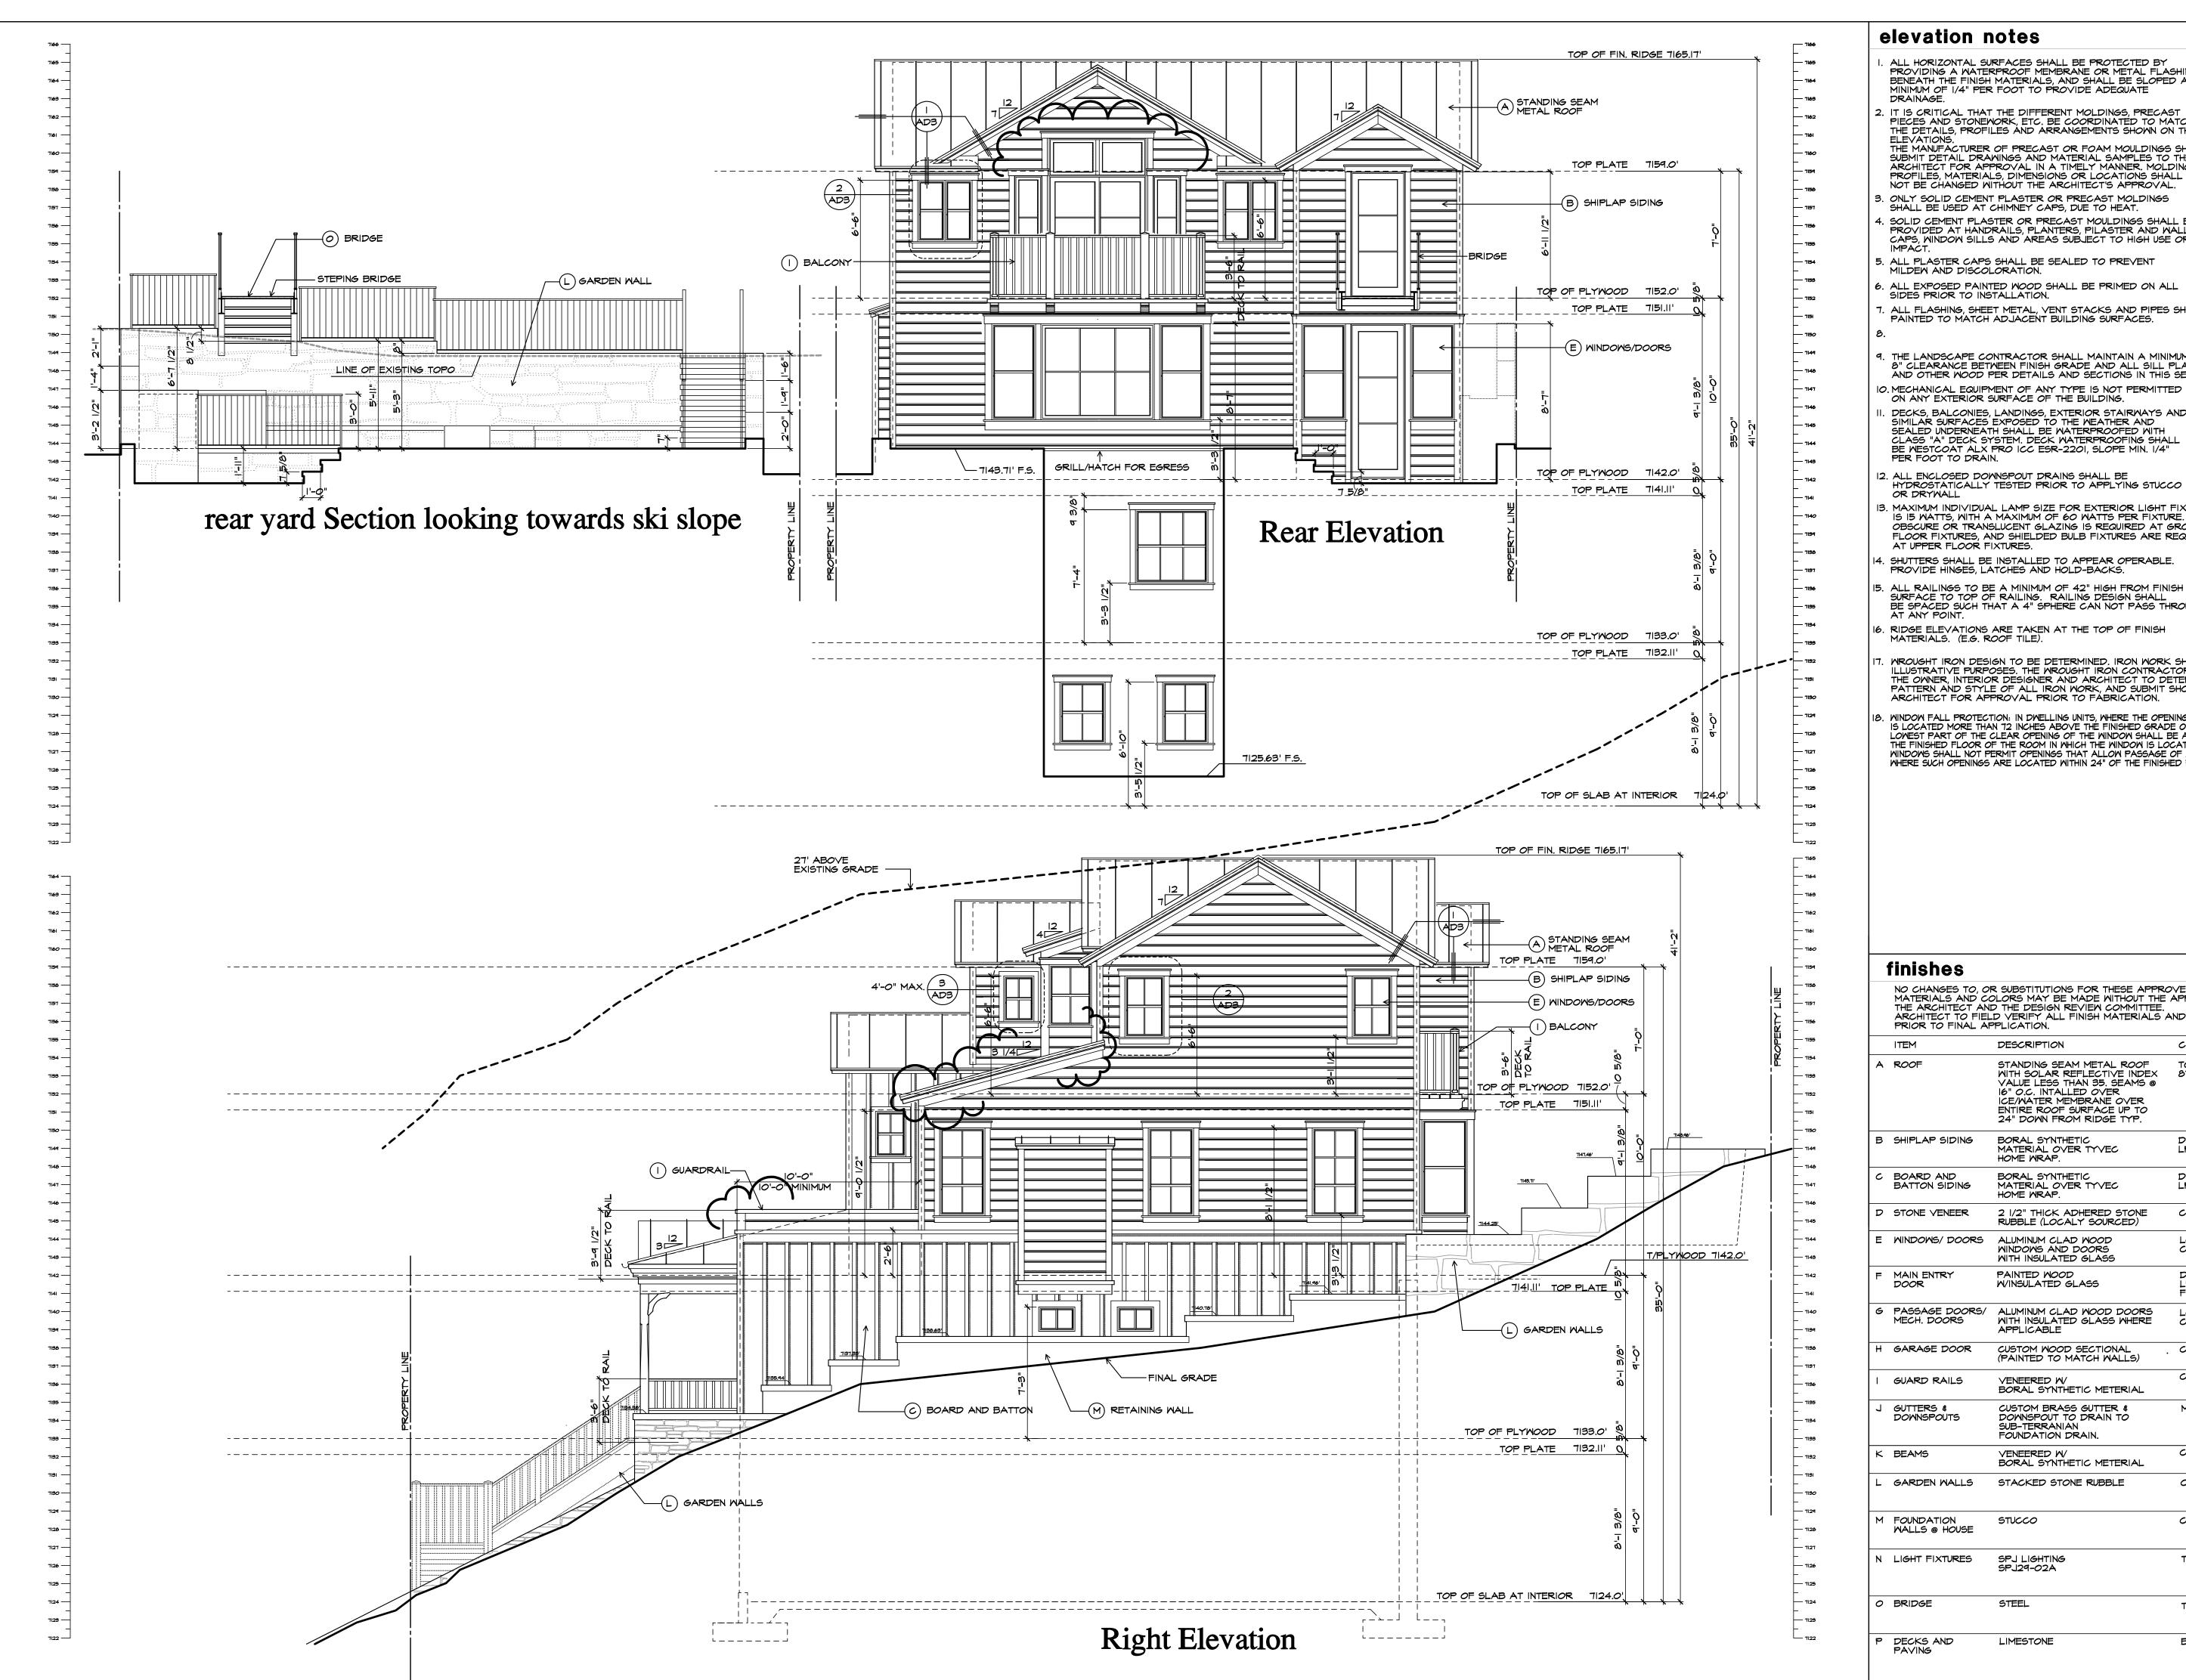


elevation notes

- ALL HORIZONTAL SURFACES SHALL BE PROTECTED BY PROVIDING A WATERPROOF MEMBRANE OR METAL FLASHING BENEATH THE FINISH MATERIALS, AND SHALL BE SLOPED A MINIMUM OF 1/4" PER FOOT TO PROVIDE ADEQUATE
- 2. IT IS CRITICAL THAT THE DIFFERENT MOLDINGS, PRECAST PIECES AND STONEWORK, ETC. BE COORDINATED TO MATCH THE DETAILS, PROFILES AND ARRANGEMENTS SHOWN ON THE THE MANUFACTURER OF PRECAST OR FOAM MOULDINGS SHALL SUBMIT DETAIL DRAWINGS AND MATERIAL SAMPLES TO THE ARCHITECT FOR APPROVAL IN A TIMELY MANNER. MOLDING PROFILES, MATERIALS, DIMENSIONS OR LOCATIONS SHALL NOT BE CHANGED WITHOUT THE ARCHITECT'S APPROVAL.
- 3. ONLY SOLID CEMENT PLASTER OR PRECAST MOLDINGS SHALL BE USED AT CHIMNEY CAPS, DUE TO HEAT.
- . SOLID CEMENT PLASTER OR PRECAST MOULDINGS SHALL BE PROVIDED AT HANDRAILS, PLANTERS, PILASTER AND WALL CAPS, WINDOW SILLS AND AREAS SUBJECT TO HIGH USE OR
- 6. ALL EXPOSED PAINTED WOOD SHALL BE PRIMED ON ALL SIDES PRIOR TO INSTALLATION.
- . ALL FLASHING, SHEET METAL, VENT STACKS AND PIPES SHALL BE PAINTED TO MATCH ADJACENT BUILDING SURFACES.
- 7. THE LANDSCAPE CONTRACTOR SHALL MAINTAIN A MINIMUM OF 8" CLEARANCE BETWEEN FINISH GRADE AND ALL SILL PLATES AND OTHER WOOD PER DETAILS AND SECTIONS IN THIS SET.
- DECKS, BALCONIES, LANDINGS, EXTERIOR STAIRWAYS AND SIMILAR SURFACES EXPOSED TO THE WEATHER AND
- SEALED UNDERNEATH SHALL BE WATERPROOFING SHALL BE WESTCOAT ALX PRO ICC ESR-2201, SLOPE MIN. 1/4" PER FOOT TO DRAIN.
- 12. ALL ENCLOSED DOWNSPOUT DRAINS SHALL BE HYDROSTATICALLY TESTED PRIOR TO APPLYING STUCCO
- 13. MAXIMUM INDIVIDUAL LAMP SIZE FOR EXTERIOR LIGHT FIXTURES IS 15 WATTS, WITH A MAXIMUM OF 60 WATTS PER FIXTURE. OBSCURE OR TRANSLUCENT GLAZING IS REQUIRED AT GROUND FLOOR FIXTURES, AND SHIELDED BULB FIXTURES ARE REQUIRED AT UPPER FLOOR FIXTURES.
- . SHUTTERS SHALL BE INSTALLED TO APPEAR OPERABLE. PROVIDE HINGES, LATCHES AND HOLD-BACKS.
- 5. ALL RAILINGS TO BE A MINIMUM OF 42" HIGH FROM FINISH SURFACE TO TOP OF RAILING. RAILING DESIGN SHALL BE SPACED SUCH THAT A 4" SPHERE CAN NOT PASS THROUGH
- . RIDGE ELEVATIONS ARE TAKEN AT THE TOP OF FINISH MATERIALS. (E.G. ROOF TILE).
- MROUGHT IRON DESIGN TO BE DETERMINED. IRON WORK SHOWN HERE IS FOR ILLUSTRATIVE PURPOSES. THE WROUGHT IRON CONTRACTOR SHALL CONSULT WITH THE OWNER, INTERIOR DESIGNER AND ARCHITECT TO DETERMINE THE ACTUAL PATTERN AND STYLE OF ALL IRON WORK, AND SUBMIT SHOP DRAWINGS TO THE ARCHITECT FOR APPROVAL PRIOR TO FABRICATION.
- WINDOW FALL PROTECTION: IN DWELLING UNITS, WHERE THE OPENING OF AN OPERABLE WINDOW IS LOCATED MORE THAN 72 INCHES ABOVE THE FINISHED GRADE OR SURFACE BELOW, THE LOWEST PART OF THE CLEAR OPENING OF THE WINDOW SHALL BE A MIN. OF 24 INCHES ABOVE THE FINISHED FLOOR OF THE ROOM IN WHICH THE WINDOW IS LOCATED. OPERABLE SECTIONS OF WINDOWS SHALL NOT PERMIT OPENINGS THAT ALLOW PASSAGE OF A 4" DIAMETER SPHERE WHERE SUCH OPENINGS ARE LOCATED WITHIN 24" OF THE FINISHED FLOOR. (CRC R312.2)


	NO CHANGES TO, OR SUBSTITUTIONS FOR THESE APPROVED FINISH MATERIALS AND COLORS MAY BE MADE WITHOUT THE APPROVAL OF THE ARCHITECT AND THE DESIGN REVIEW COMMITTEE. ARCHITECT TO FIELD VERIFY ALL FINISH MATERIALS AND COLORS PRIOR TO FINAL APPLICATION.					
	ITEM	DESCRIPTION	COLOR NAME			
A	ROOF	STANDING SEAM METAL ROOF WITH SOLAR REFLECTIVE INDEX VALUE LESS THAN 35. SEAMS @ 16" O.C. INTALLED OVER ICE/WATER MEMBRANE OVER ENTIRE ROOF SURFACE UP TO 24" DOWN FROM RIDGE TYP.	TO MATCH FRAZEE: 8773M DAUPHIN GREY			
В	SHIPLAP SIDING	BORAL SYNTHETIC MATERIAL OVER TYVEC HOME WRAP.	DUNN EDWARDS LRV 81 DEW340 WHISPER			
C	BOARD AND BATTON SIDING	BORAL SYNTHETIC MATERIAL OVER TYVEC HOME WRAP.	DUNN EDWARDS LRV 81 DEW340 WHISPER			
D	STONE VENEER	2 1/2" THICK ADHERED STONE RUBBLE (LOCALY SOURCED)	CREAM/ TAN			
E	MINDOWS/ DOORS	ALUMINUM CLAD WOOD WINDOWS AND DOORS WITH INSULATED GLASS	LOEMEN COLOR TO MATCH SIDING			
F	MAIN ENTRY DOOR	PAINTED WOOD WINSULATED GLASS	DUNN EDWARDS LRY 80 DE5028 FAIRY WINGS			
6	PASSAGE DOORS/ MECH. DOORS	ALUMINUM CLAD WOOD DOORS WITH INSULATED GLASS WHERE APPLICABLE	LOEMEN COLOR TO MATCH SIDING			
H	GARAGE DOOR	CUSTOM WOOD SECTIONAL (PAINTED TO MATCH WALLS)	COLOR TO MATCH SIDING			
ı	GUARD RAILS	VENEERED W/ BORAL SYNTHETIC METERIAL	COLOR TO MATCH SIDING			
7	GUTTERS & DOWNSPOUTS	CUSTOM BRASS GUTTER & DOWNSPOUT TO DRAIN TO SUB-TERRANIAN FOUNDATION DRAIN.	MATCH ROOF COLOR			
K	BEAMS	VENEERED W/ BORAL SYNTHETIC METERIAL	COLOR TO MATCH SIDING			
L	GARDEN WALLS	STACKED STONE RUBBLE	CREAM/ TAN			
М	FOUNDATION WALLS @ HOUSE	STUCCO	CALOR TO MATCH SIDING			
N	LIGHT FIXTURES	SPJ LIGHTING SPJ29-02A	TO MATCH ROOF			


TO MATCH ROOF

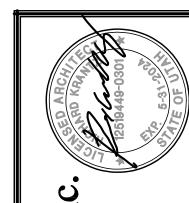

ations E rior

CHECKED DATE 2/3/2023 REVISION SCALE |/4" = |'-0" SHEET NO.

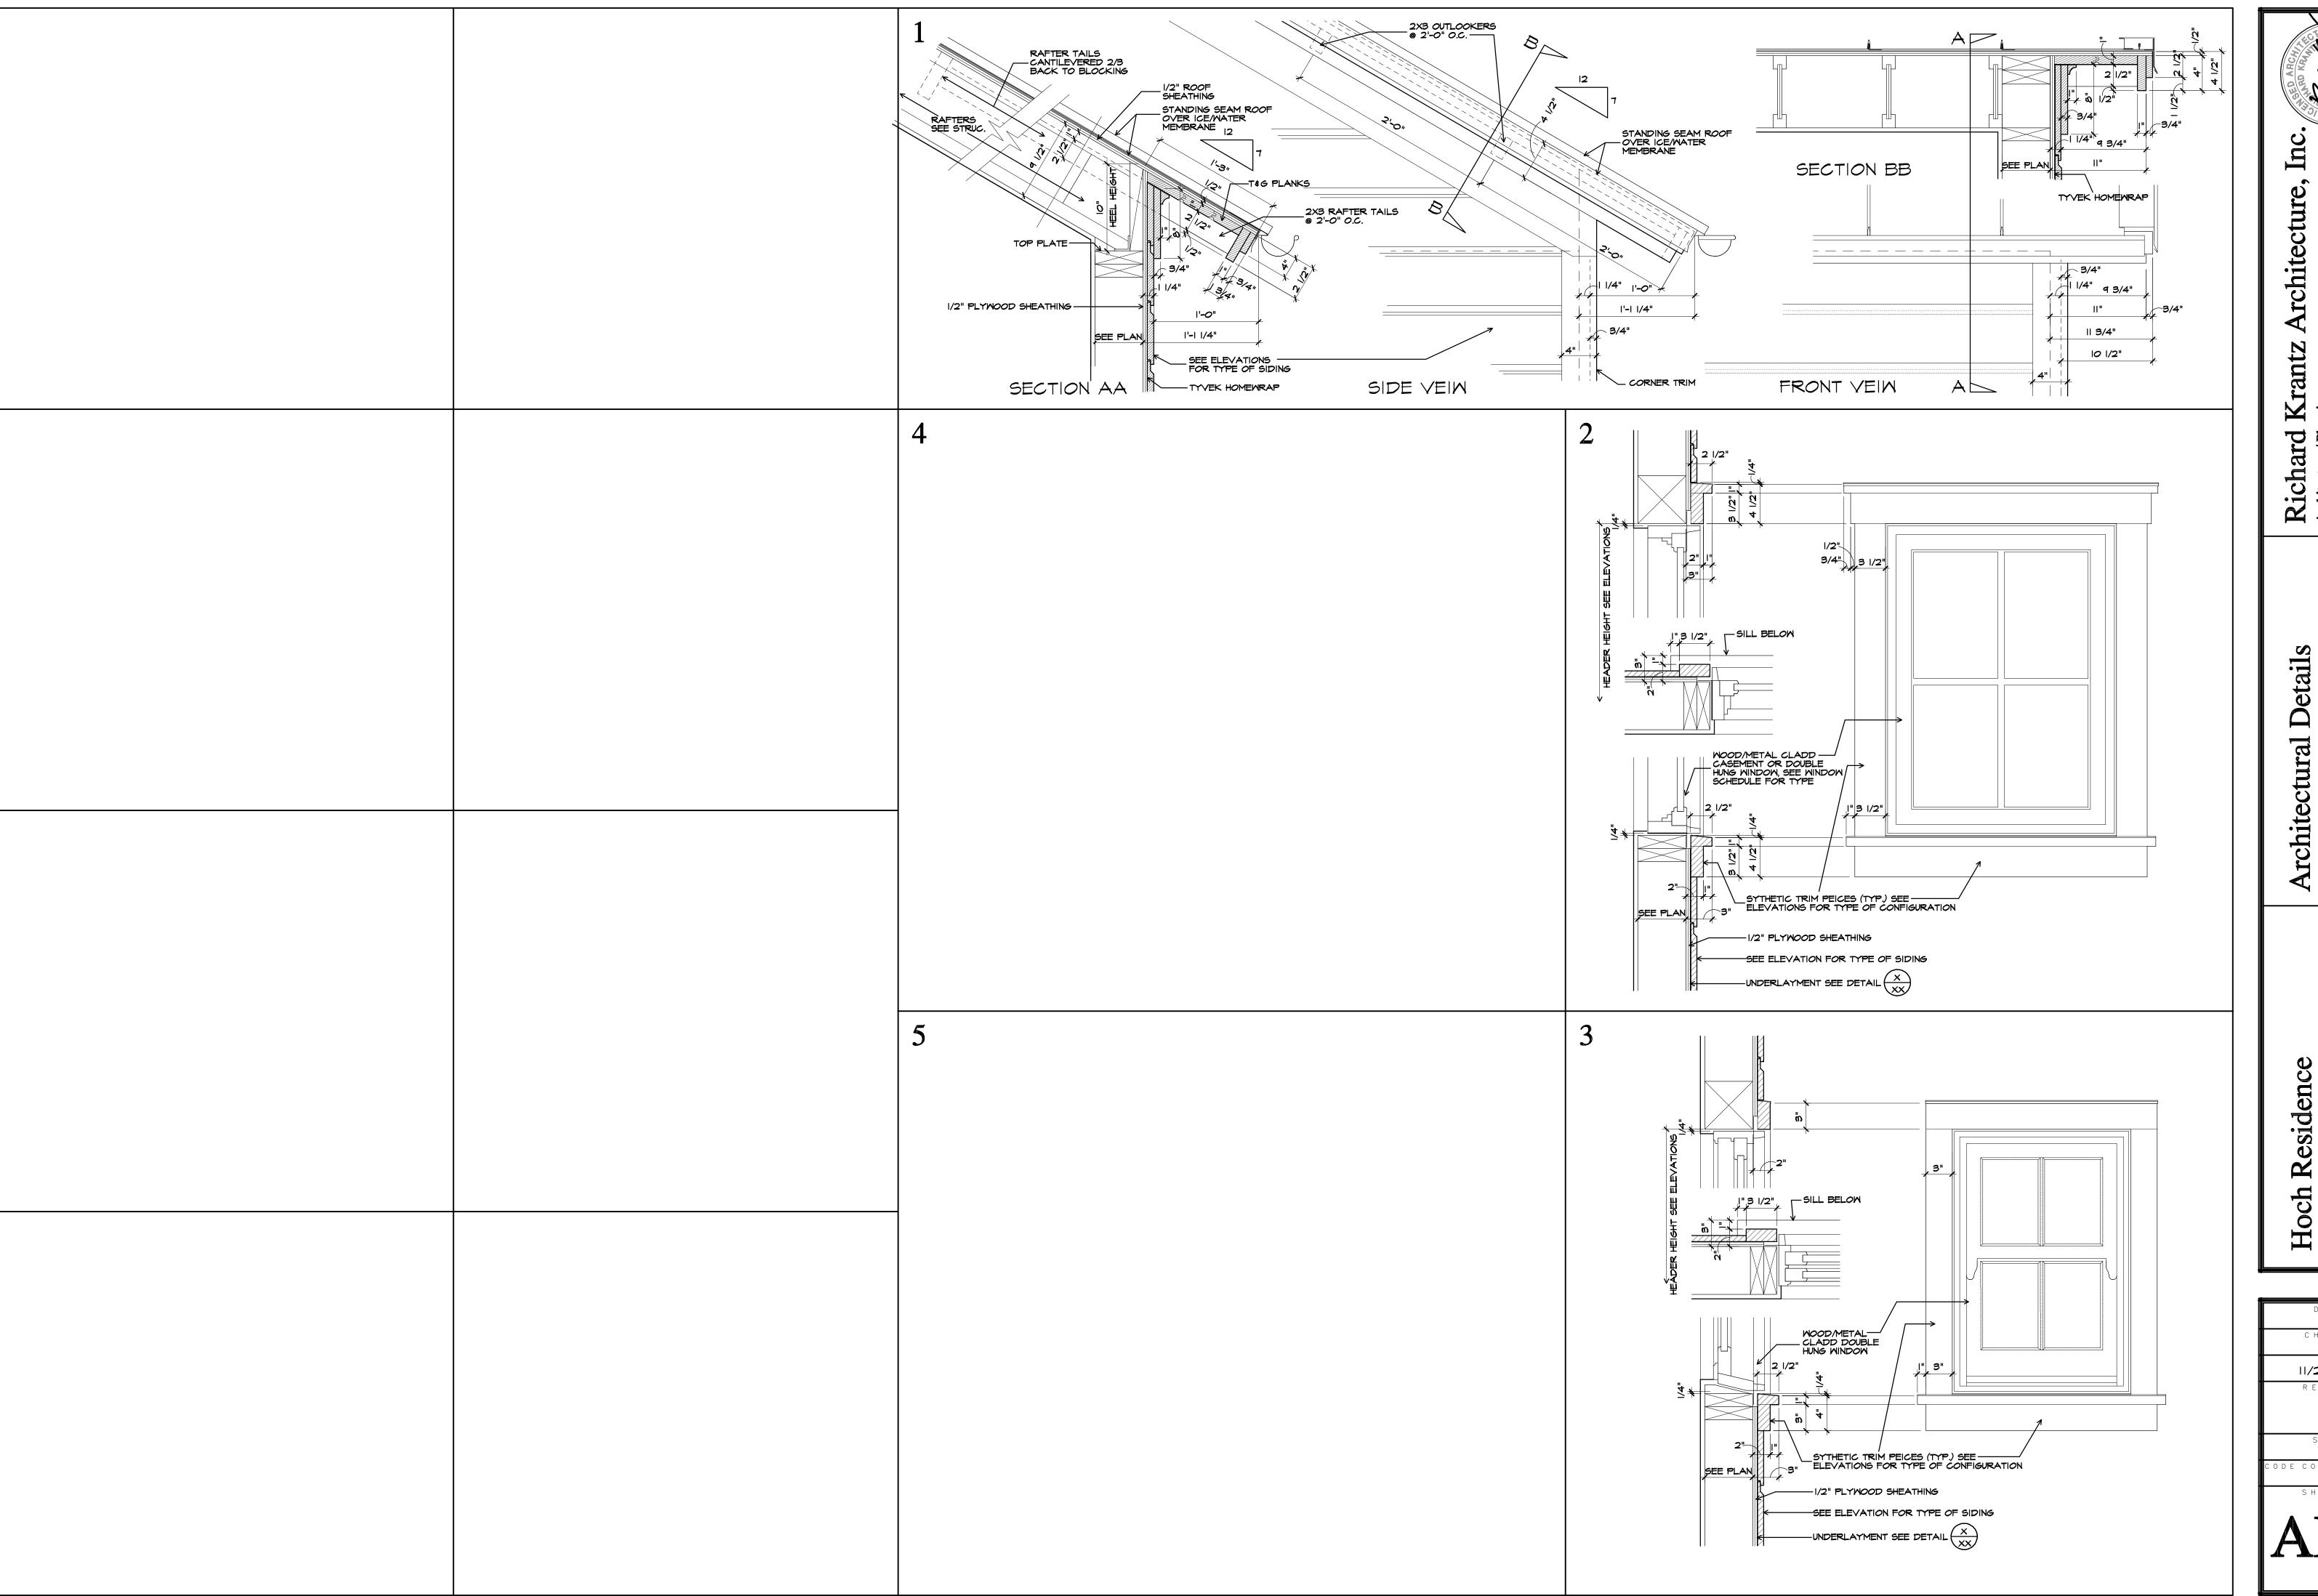

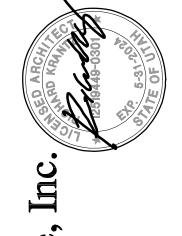

Hoch Residence

475 Woodside Avenue

Park City, UT 84060

Park City, UT 84060

Architectural Details

Architectura

DRAWN

CHECKED

R.K.

DATE


II/28/2022

REVISION

SCALE

CODE COMPLIANCE NO.

SHEET NO.

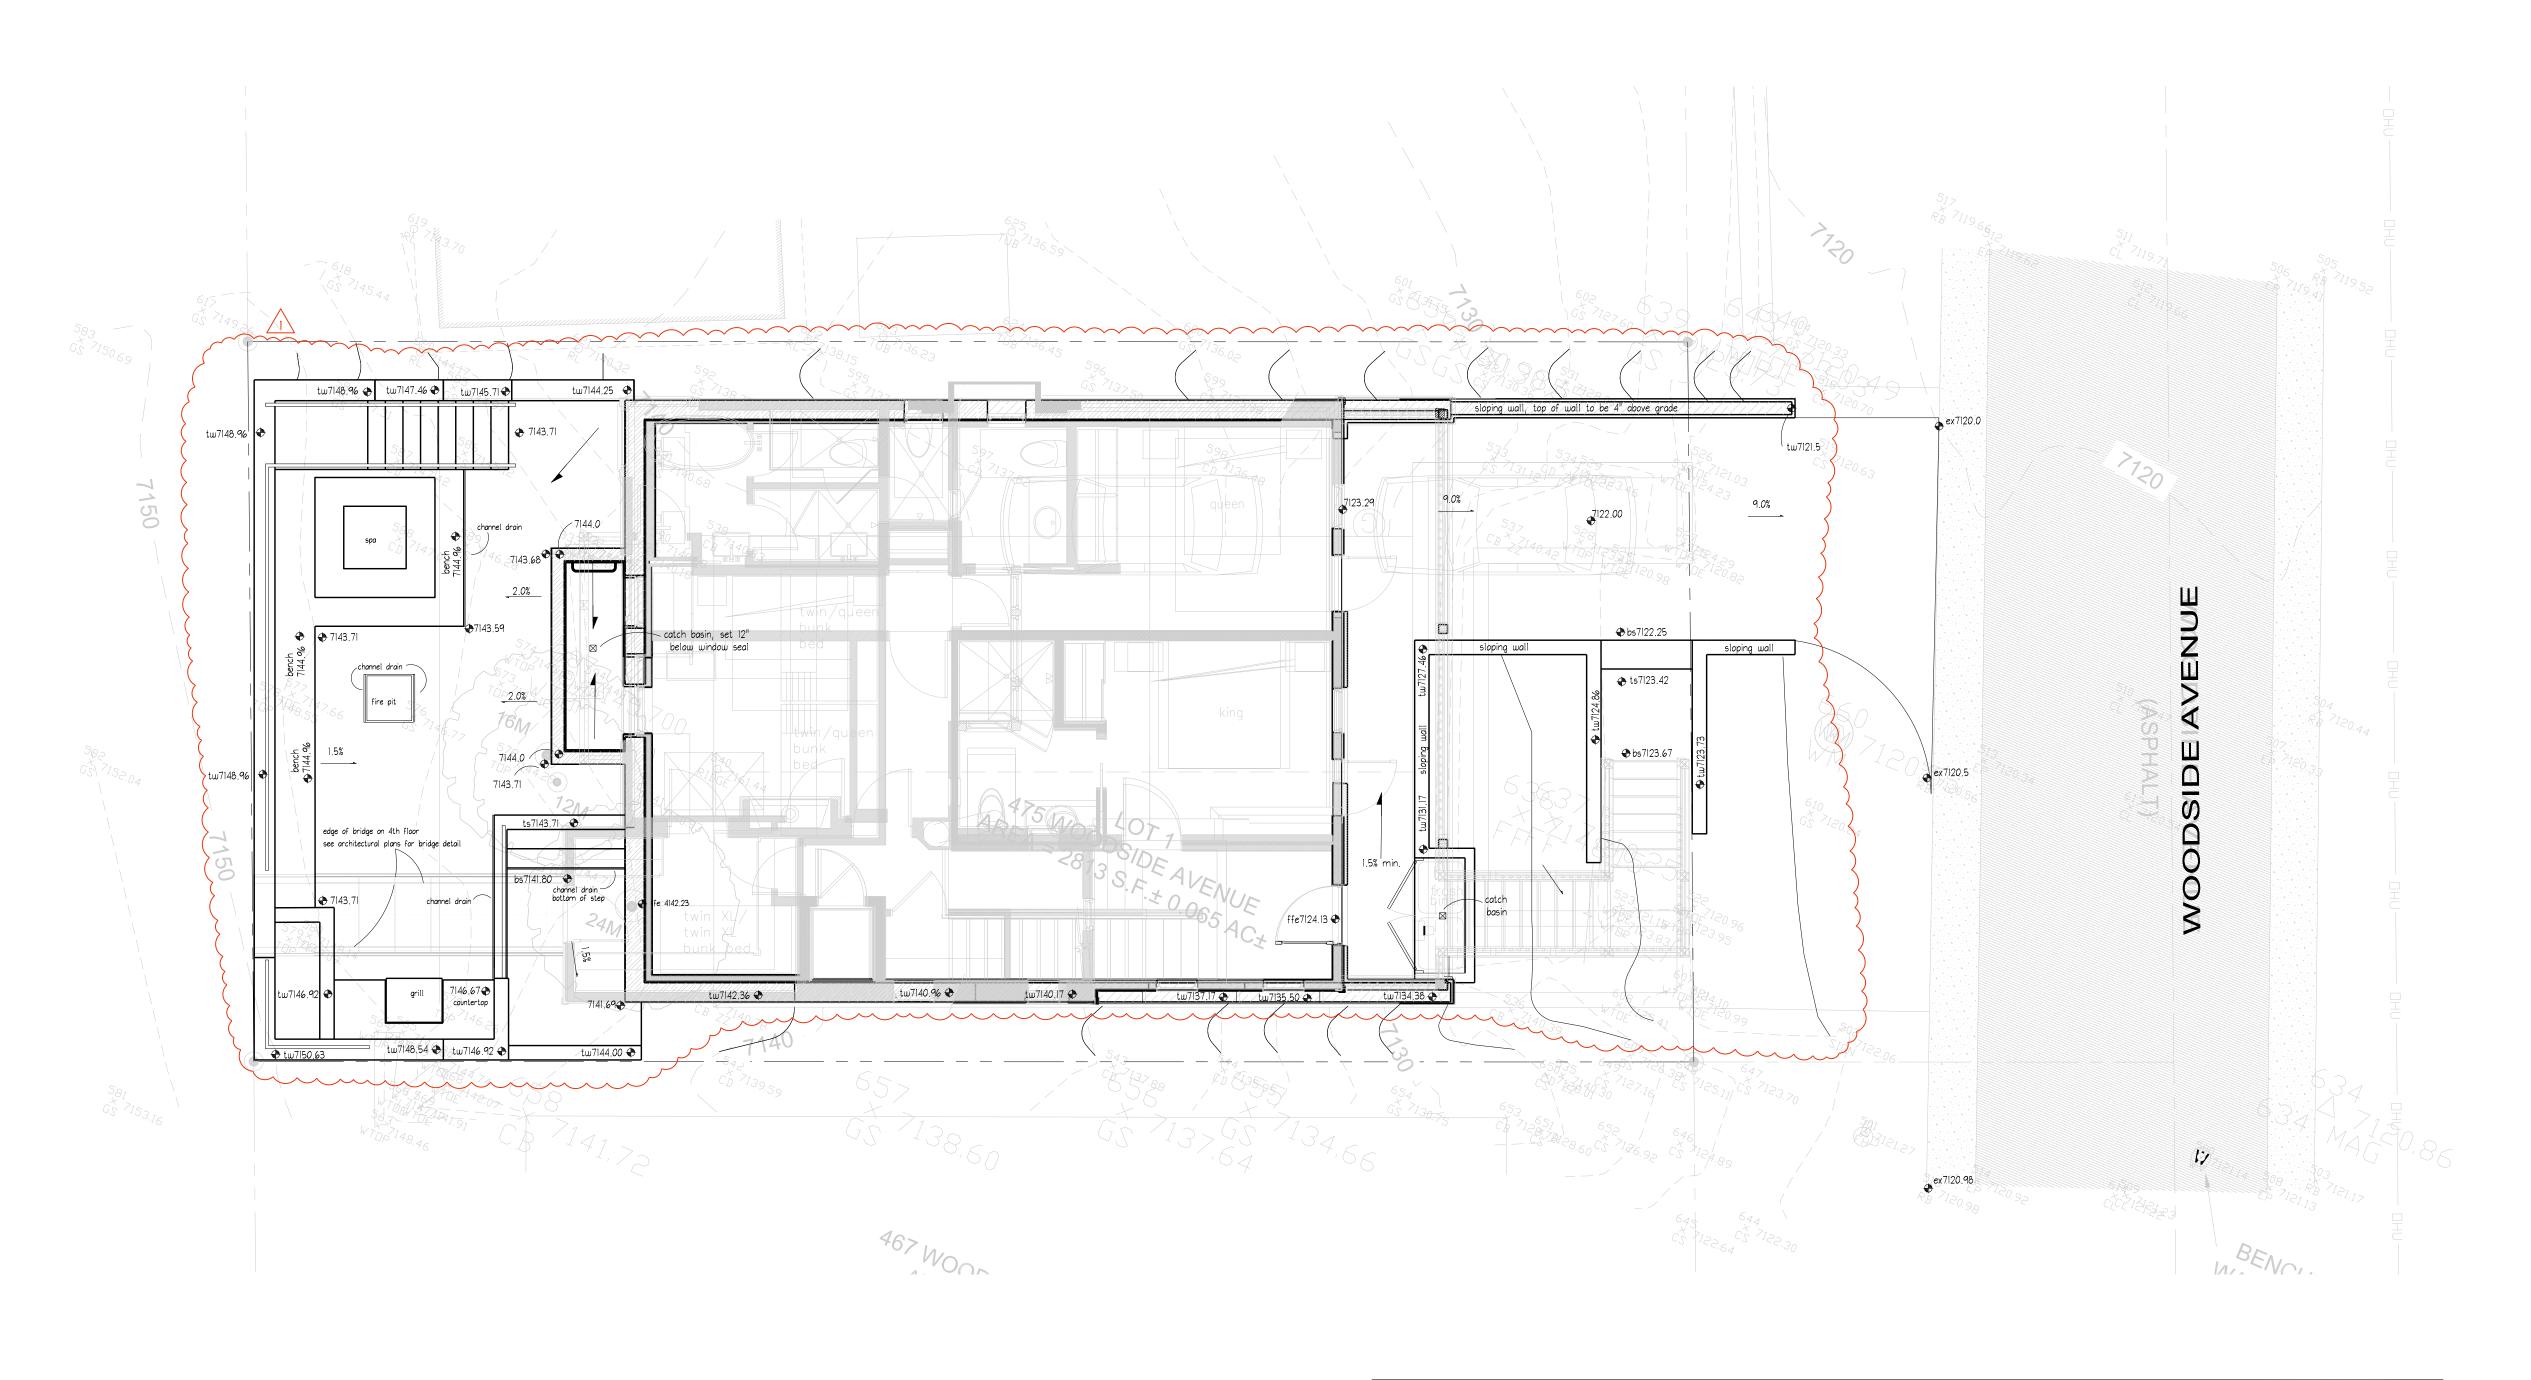

LEGEND ◆ tw/bw4325 TOP OF WALL/ BOTTOM OF WALL bs/ts4325 EXISTING SPOT ELEVATION BOTTOM/TOP OF STAIRS PROPOSED SPOT ELEVATION CATCH BASIN RIM ELEVATION 4325 ♦ hp/lp4325 HIGH POINT / LOW POINT tb4325 TOP OF BENCH 1.5% DIRECTION OF FLOW \$ SLOPE INDICATOR ◆ ex4325 EXISTING GRADE GRADING \$ LAYOUT NOTES FINISHED GRADES, CONTOURS, AND ELEVATIONS INDICATED ON THE GRADING AND DRAINAGE PLAN DESCRIBE FINAL SURFACE ELEVATIONS FOR COMPLETED CONSTRUCTION. THE CONTRACTOR SHALL REVIEW THE DETAILS AND SPECIFICATIONS TO ASCERTAIN SPECIFIC WORK LIMITS AND REQUIREMENTS. 2. CONTRACTOR SHALL VERIFY ALL EXISTING GRADES IN THE FIELD AND REPORT ANY DISCREPANCIES TO THE OWNER'S REPRESENTATIVE. 3. CONSULT ALL OF THE DRAWINGS AND SPECIFICATIONS FOR COORDINATION REQUIREMENTS BEFORE COMMENCING CONSTRUCTION. 4. WHERE NEW PAVING OR EARTHWORK MEETS EXISTING PAVING OR EARTHWORK SMOOTHLY BLEND LINE AND GRADE OF EXISTING WITH NEW. ALL RIDGES AND VALLEYS SHALL HAVE A SMOOTH TRANSITIONS. 5. GRADE EVENLY BETWEEN SPOT GRADES SHOWN ON DRAWINGS. ALL PAVED AREAS MUST GRADE TO DRAIN AT A MINIMUM OF ONE-EIGHTH INCH (1/8") PER FOOT. ANY DISCREPANCIES NOT ALLOWING THIS TO OCCUR SHALL BE REPORTED TO THE OWNERS REPRESENTATIVE PRIOR TO CONTINUING WORK. 6. PRIOR TO COMMENCING ANY EXCAVATION WORK, THE CONTRACTOR SHALL NOTIFY ALL UTILITY COMPANIES IN ACCORDANCE WITH THE REQUIRED PROCEDURES. 7. THE LOCATION OF UNDERGROUND UTILITIES SHOWN ON THIS PLAN ARE DIAGRAMMATIC ONLY, AND ALL UTILITIES MAY NOT BE SHOWN. THE CONTRACTOR SHALL CONTACT THE PROPER LOCAL AUTHORITIES OR RESPECTIVE UTILITY COMPANY TO CONFIRM THE LOCATION OF ALL EXISTING UTILITIES BEFORE COMMENCING WORK. ANY DAMAGE DUE TO FAILURE OF THE CONTRACTOR TO CONTACT THE PROPER AUTHORITIES SHALL BE BORNE BY THE CONTRACTOR. 8. EXCAVATION REQUIRED WITHIN PROXIMITY OF EXISTING UTILITY LINES SHALL BE DONE BY HAND. CONTRACTOR SHALL REPAIR ANY DAMAGE TO EXISTING UTILITY LINES OR STRUCTURES INCURRED DURING CONSTRUCTION OPERATIONS AT NO COST TO OWNER. 9. ANY AREA DISTURBED OUTSIDE THE LIMIT OF DISTURBANCE/PROPERTY LINE SHALL BE RESTORED TO ITS ORIGINAL CONDITIONS AT NO COST TO OWNER. 10. CONTRACTOR SHALL SUPPLY AND MAINTAIN FOR THE DURATION OF CONSTRUCTION ALL NECESSARY DEVICES FOR EROSION, SEDIMENT AND DUST CONTROL, SUCH AS HAY BALES, GRAVEL, BOARDS, ETC., INCLUDING THOSE DEVICES NECESSARY FOR STOCKPILES AND PROTECTION OF ADJACENT PUBLIC WAYS AND SHALL REMOVE THE DEVICES AFTER PROJECT CLOSEOUT. II. REFER TO STRUCTURAL DETAILS AND RECOMMENDATIONS FOR ROCK WALL CONSTRUCTION. 12. CUT AND FILL SLOPES SHALL BE CONSTRUCTED AS RECOMMENDED BY THE GEOTECHNICAL REPORT. 13. INSTALL DRAINAGE PIPE ON BACKSIDE OF RETAINING WALLS AND SLOPE TO DAYLIGHT DRAINS AS REQUIRED SCALE # NORTH ARROW

Are Sitio Design, Inc Landscape Architecture & Architectural Site Design

1058 East 2100 South Salt Lake City, Utah 84106 office 801 . 487 . 4923 fax 801 . 466 . 3046 www.arcsitiodesign.com



consultant:

projec

475 Woodside Residence

date

nne

MAY 10, 2022

revisions
2/13/2023


data asd project

sd project no:

title GRADING PLAN

sheet

LG101

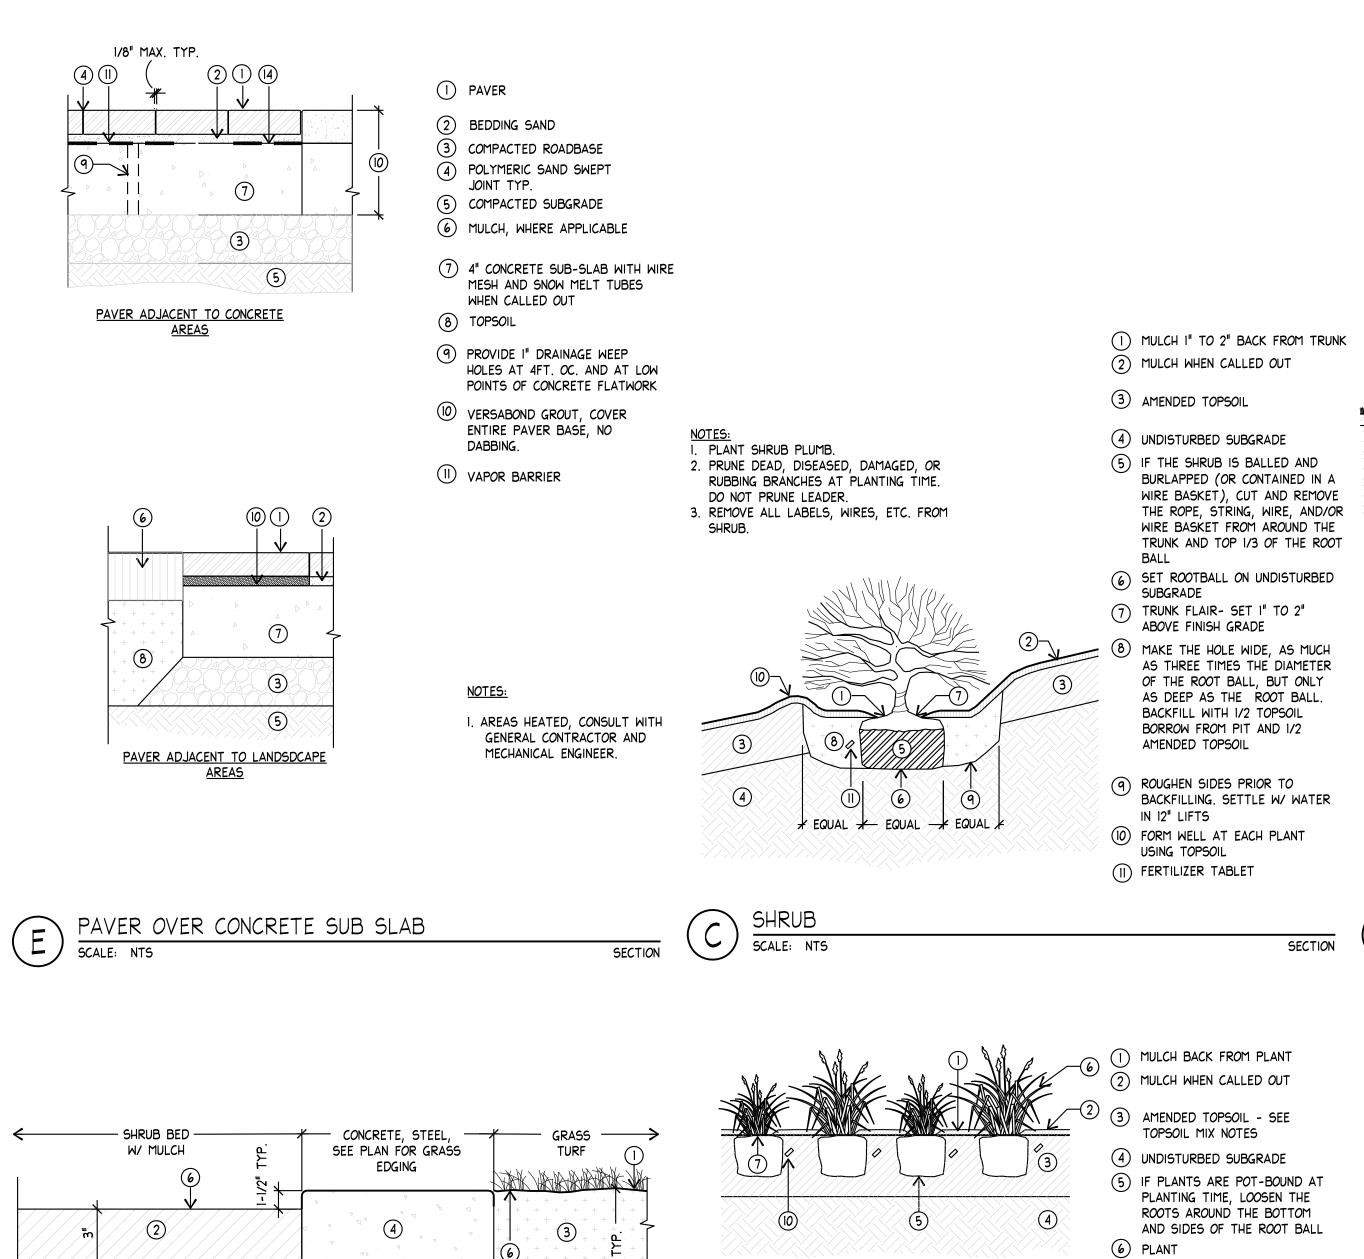

3

MULCH WITH TOPSOIL

SCALE: NTS

(5)

(7) ROAD BASE, WHEN

APPLICABLÉ

1 TURF GRASS

3 AMENDED TOPSOIL

(4) LANDSCAPE EDGING

5 SUBGRADE

6 FINISH GRADE


(2) PEP SOIL FINE MULCH, OR

<u>SECTION</u>

<u>PLAN</u>

PERENNIAL / GROUNDCOVER

SCALE: NTS

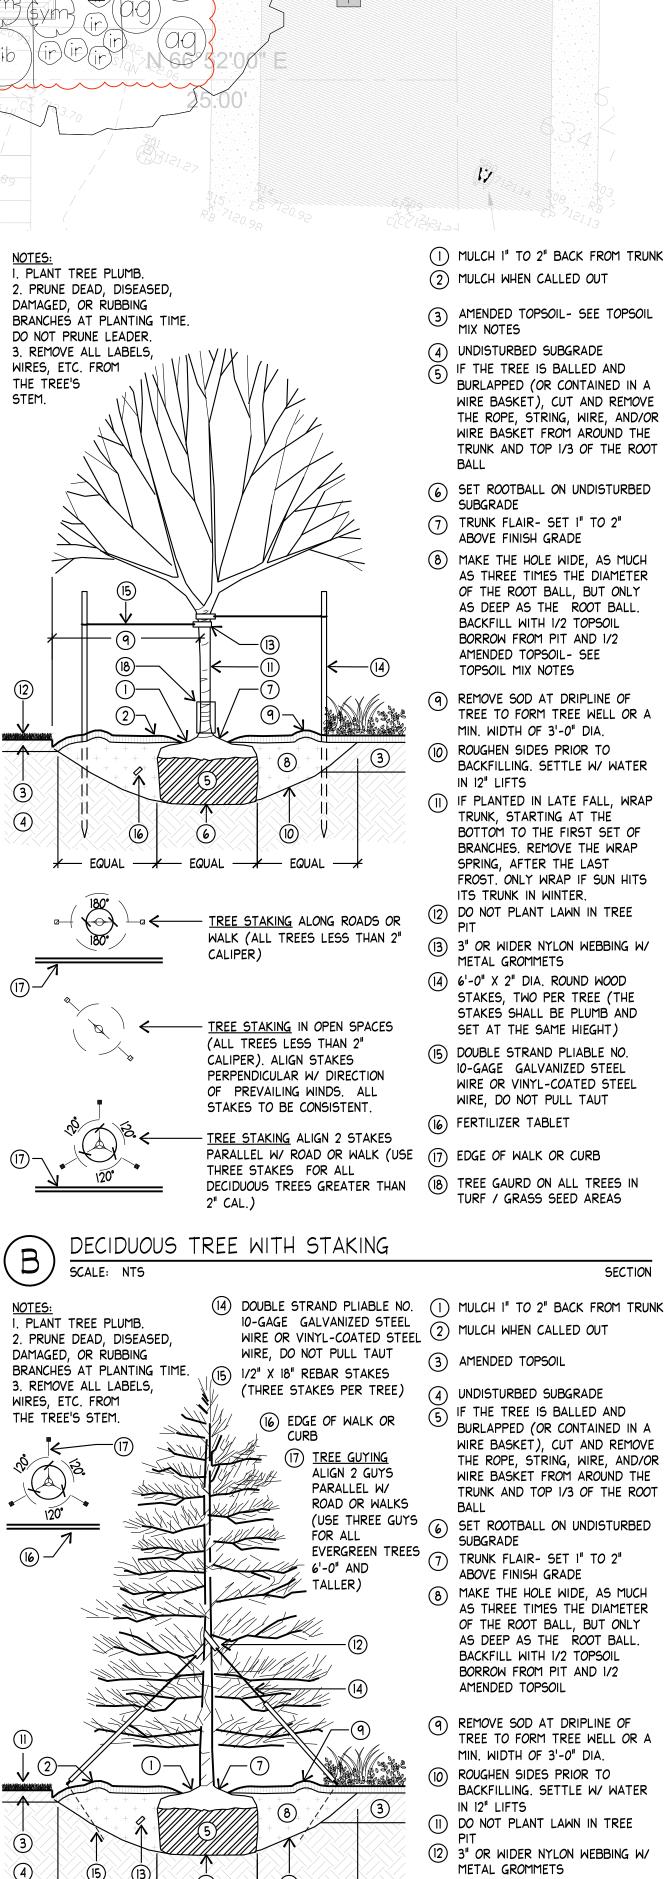

(13) FERTILIZER TABLET

SECTION

EVERGREEN TREE WITH GUYING

SCALE: NTS

7) BE SURE THE CROWN OF THE

PLANT (THE POINT WHERE

WITH THE SOIL SURFACE

(9) CENTER OF PLANT

FERTILIZER TABLET

(8) PLANT SPACING VARIES - REFER TO PLANT SCHEDULE OR PLAN

I. PRUNE DEAD, DISEASED,

BRANCHES AT PLANTING TIME.

3. WATER PLANTS THOROUGHLY

FOLLOWING PLANTING TO SETTLE THE SOIL AROUND THE ROOTS.

SECTION/PLAN

2. REMOVE ALL LABELS, WIRES,

DAMAGED, OR RUBBING

ETC. FROM PLANT.

ROOTS AND TOP JOIN) IS EVEN

PLANTING NOTES A

CONTRACTOR SHALL BE RESPONSIBLE FOR MAKING HIMSELF FAMILIAR WITH ALL UNDERGROUND UTILITIES, PIPES AND STRUCTURES.
CONTRACTOR SHALL TAKE SOLE RESPONSIBILITY FOR ANY COSTS INCURRED DUE TO DAMAGE OF SAID UTILITIES.

CONTRACTOR SHALL NOT WILLFULLY PROCEED WITH CONSTRUCTION AS DESIGNED WHEN IT IS OBVIOUS THAT OBSTRUCTIONS AND/OR GRADE DIFFERENCES EXIST THAT MAY NOT HAVE BEEN KNOWN DURING DESIGN. SUCH CONDITIONS SHALL BE IMMEDIATELY BROUGHT TO THE ATTENTION OF THE OWNERS REP. THE CONTRACTOR SHALL ASSUME FULL RESPONSIBILITY FOR ALL NECESSARY REVISIONS DUE TO FAILURE TO GIVE SUCH NOTIFICATION.


- CONTRACTOR SHALL BE RESPONSIBLE FOR ANY COORDINATION WITH SUBCONTRACTORS AS REQUIRED TO ACCOMPLISH THE LANDSCAPE CONSTRUCTION FOR THIS PROJECT.
- ALL PLANT MATERIAL SHALL BE APPROVED BY THE OWNER'S REPRESENTATIVE UPON DELIVERY TO THE SITE, AND PRIOR TO INSTALLATION. ANY PROPOSED SUBSTITUTIONS OF PLANT SPECIES SHALL BE MADE WITH PLANTS OF EQUIVALENT OVERALL FORM, HEIGHT, BRANCHING HABIT, FLOWER, LEAF, COLOR, FRUIT AND CULTURE ONLY AS APPROVED BY THE OWNER'S REPRESENTATIVE.
- THE CONTRACTOR SHALL SUPPLY ALL PLANT MATERIAL IN QUANTITIES SUFFICIENT TO COMPLETE THE PLANTING SHOWN ON THE DRAWINGS. IF DISCREPANCIES ARISE BETWEEN ACTUAL PLANTING AREA SIZES IN THE FIELD AND THOSE SHOWN ON THE PLANS, CONTRACTOR SHALL CONTACT THE OWNER'S REPRESENTATIVE FOR RESOLUTION. FAILURE TO MAKE SUCH CONFLICTS KNOWN WILL RESULT IN CONTRACTOR'S LIABILITY FOR MATERIALS RELOCATION.
- FINAL LOCATIONS OF ALL PLANT MATERIALS SHALL BE SUBJECT TO APPROVAL OF THE OWNER'S REPRESENTATIVE. TREES SHALL NOT BE PLANTED LESS THAN 5'-0" FROM CURBS OR HARD SURFACE AREAS UNLESS A ROOT BARRIER IS INSTALLED.
- CONTRACTOR SHALL PROVIDE SOIL ANALYSIS AND AMMEND SOIL AS RECOMMENDED. LANDSCAPE CONTRACTOR IS RESPONSIBLE FOR THE LAST 7 INCHES OF GRADE IN TURF SOD AREAS (6 INCHES OF TOPSOIL AND I INCH FOR SOD) AND IS INCHES IN SHRUB BED AREAS (3 INCHES OF BARK MULCH AND 12" OF AMENDED TOPSOIL). IF NECESSARY DIG SUBGRADE IN SHRUB BEDS AND TURF AREAS DOWN AS SPECIFIED BEFORE PLACING AMENDED TOPSOIL. THE PLANTING ISLANDS IN THE PARKING LOTS SHALL HAVE ALL ROAD BASE REMOVED PRIOR TO PLACEMENT OF TOPSOIL. REFER TO GRADING PLAN FOR FINISH GRADE AND DRAINAGE.

PLANT SCI	BOTANICAL NAME	COMMON NAME	CONT	<u>CAL</u>	<u>SIZE</u>	QT`
< · }	Acer buergerianum	Trident Maple	B # B	2"		I
EVERGREEN	BOTANICAL NAME	COMMON NAME	CONT	CAL	<u>SIZE</u>	<u>at</u>
· ·	Pinus sylvestris 'Glauca Nana'	Dwarf Scotch Pine	B & B	SPECIMEN	-	I
SHRUBS	BOTANICAL NAME	COMMON NAME	<u>SIZE</u>			\sim
(rib)	Ribes alpinum	Alpine Currant	5 gal			8
Sym	Symphoricarpos albus	Common White Snowberry	5 gal		\triangle	29
<u>GRASSES</u>	BOTANICAL NAME	COMMON NAME	SIZE			
	Calamagrostis acutifolia 'Overdam'	Overdam Reed Grass	l gal			8
	Festuca mairei	Atlas Fescue	l gal			6
PERENNIALS	BOTANICAL NAME	COMMON NAME	<u>SIZE</u>			
	Aquilegia alpina	Alpine Columbine	l gal			12
(rr)	Hemerocallis hybrid 'Rosy Returns'	Rosy Returns Daylily	l gal			33
(ir)	lris pallida 'Aureo Variegata'	Variegated Yellow Blade Iris	l gal		(33
ag	Nepeta x faassenii 'Blue Wonder'	Catmint	l gal			4
(nit)	Rudbeckia fulgida 'Goldsturm'	Goldsturm Black-eyed Susan	l gal			8
* QUANTIT	Y INFORMATION PROVIDED FOR REFERENCE ONLY	r. Contractor responsible to verify a	LL QUANTITI	ES.		

REFERE	ENCE SCHEDULE NOTES	(
SYMBOL	DESCRIPTION QTY	*
	3" DEEP SOIL PEP MULCH OVER 12" OF TOPSOIL, TYP., 856 sf SEE DETAIL F	
2	3"x3"x3" FRACTURED ALL SIDES BUT ONE SIDE CUT GRANITE COBBLES SET ON HEATED CONCRETE DRIVE, TYP. SEE DETAIL E	
3	6"X 2"X /4" BEIGE GRANITE PAVER WITH FLAMED FINISH, OVER HEATED CONCRETE SUB SLAB, TYP. SEE DETAIL E	
4	3/4" TO 1/2" TAN CRUSHED GRAVEL, TYP. SEE DETAIL 30 sf	
5	77" \times 77" 6 PERSON HOT TUB, INSTALL PER CODE AND MANUFACTURERS INSTRUCTIONS.	
6	RETAINING WALL, SEE STRUCTURAL, CIVIL, AND ARCHITECTURAL SITE PLAN FOR GRADES	
7	STAIRCASE, SEE ARCHITECTURAL AND SITE PLAN FOR GRADES	
8	BUILT IN BENCH TO SURROUND HOT TUB AND FIRE ELEMENT (ADD CUSHIONS IF DESIRED) STONE VENEEER FACE AND STONE CAP WALL TO MATCH HOUSE STONE	
9	2' 6" \times 2' 6" \times 18" HIGH CORETEN STEEL GAS FIRE ELEMENT, INSTALL PER ALL CODES	
TI.	BBQ GAS GRILL	
12	GRANITE COUNTERTOP	
13	BRIDGE, SEE STRUCTURAL AND ARCHITECTURAL PLANS	
15	EXISTING TREE TO BE REMOVED, SEE DEMOLITION PLAN	
	* QUANTITY INFORMATION PROVIDED FOR REFERENCE ONLY. CONTRACTOR RESPONSIBLE TO VERIFY ALL QUANTITIES.	
LALE	\$ NORTH ARROW	

Are S i t i o
D e s i g n, I n c
Landscape Architecture &
Architectural Site Design

1058 East 2100 South Salt Lake City, Utah 84106 office 801 487 4923 fax 801 466 3046 www.arcsitiodesign.com

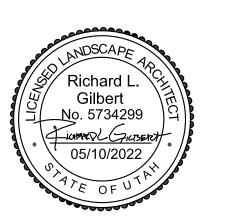

consultant:

project

475 Woodside Residence

date

MAY 10, 2022

revisions

data asd project no:


....

title LANDSCAPE


LANDOCAF

sheet

L101

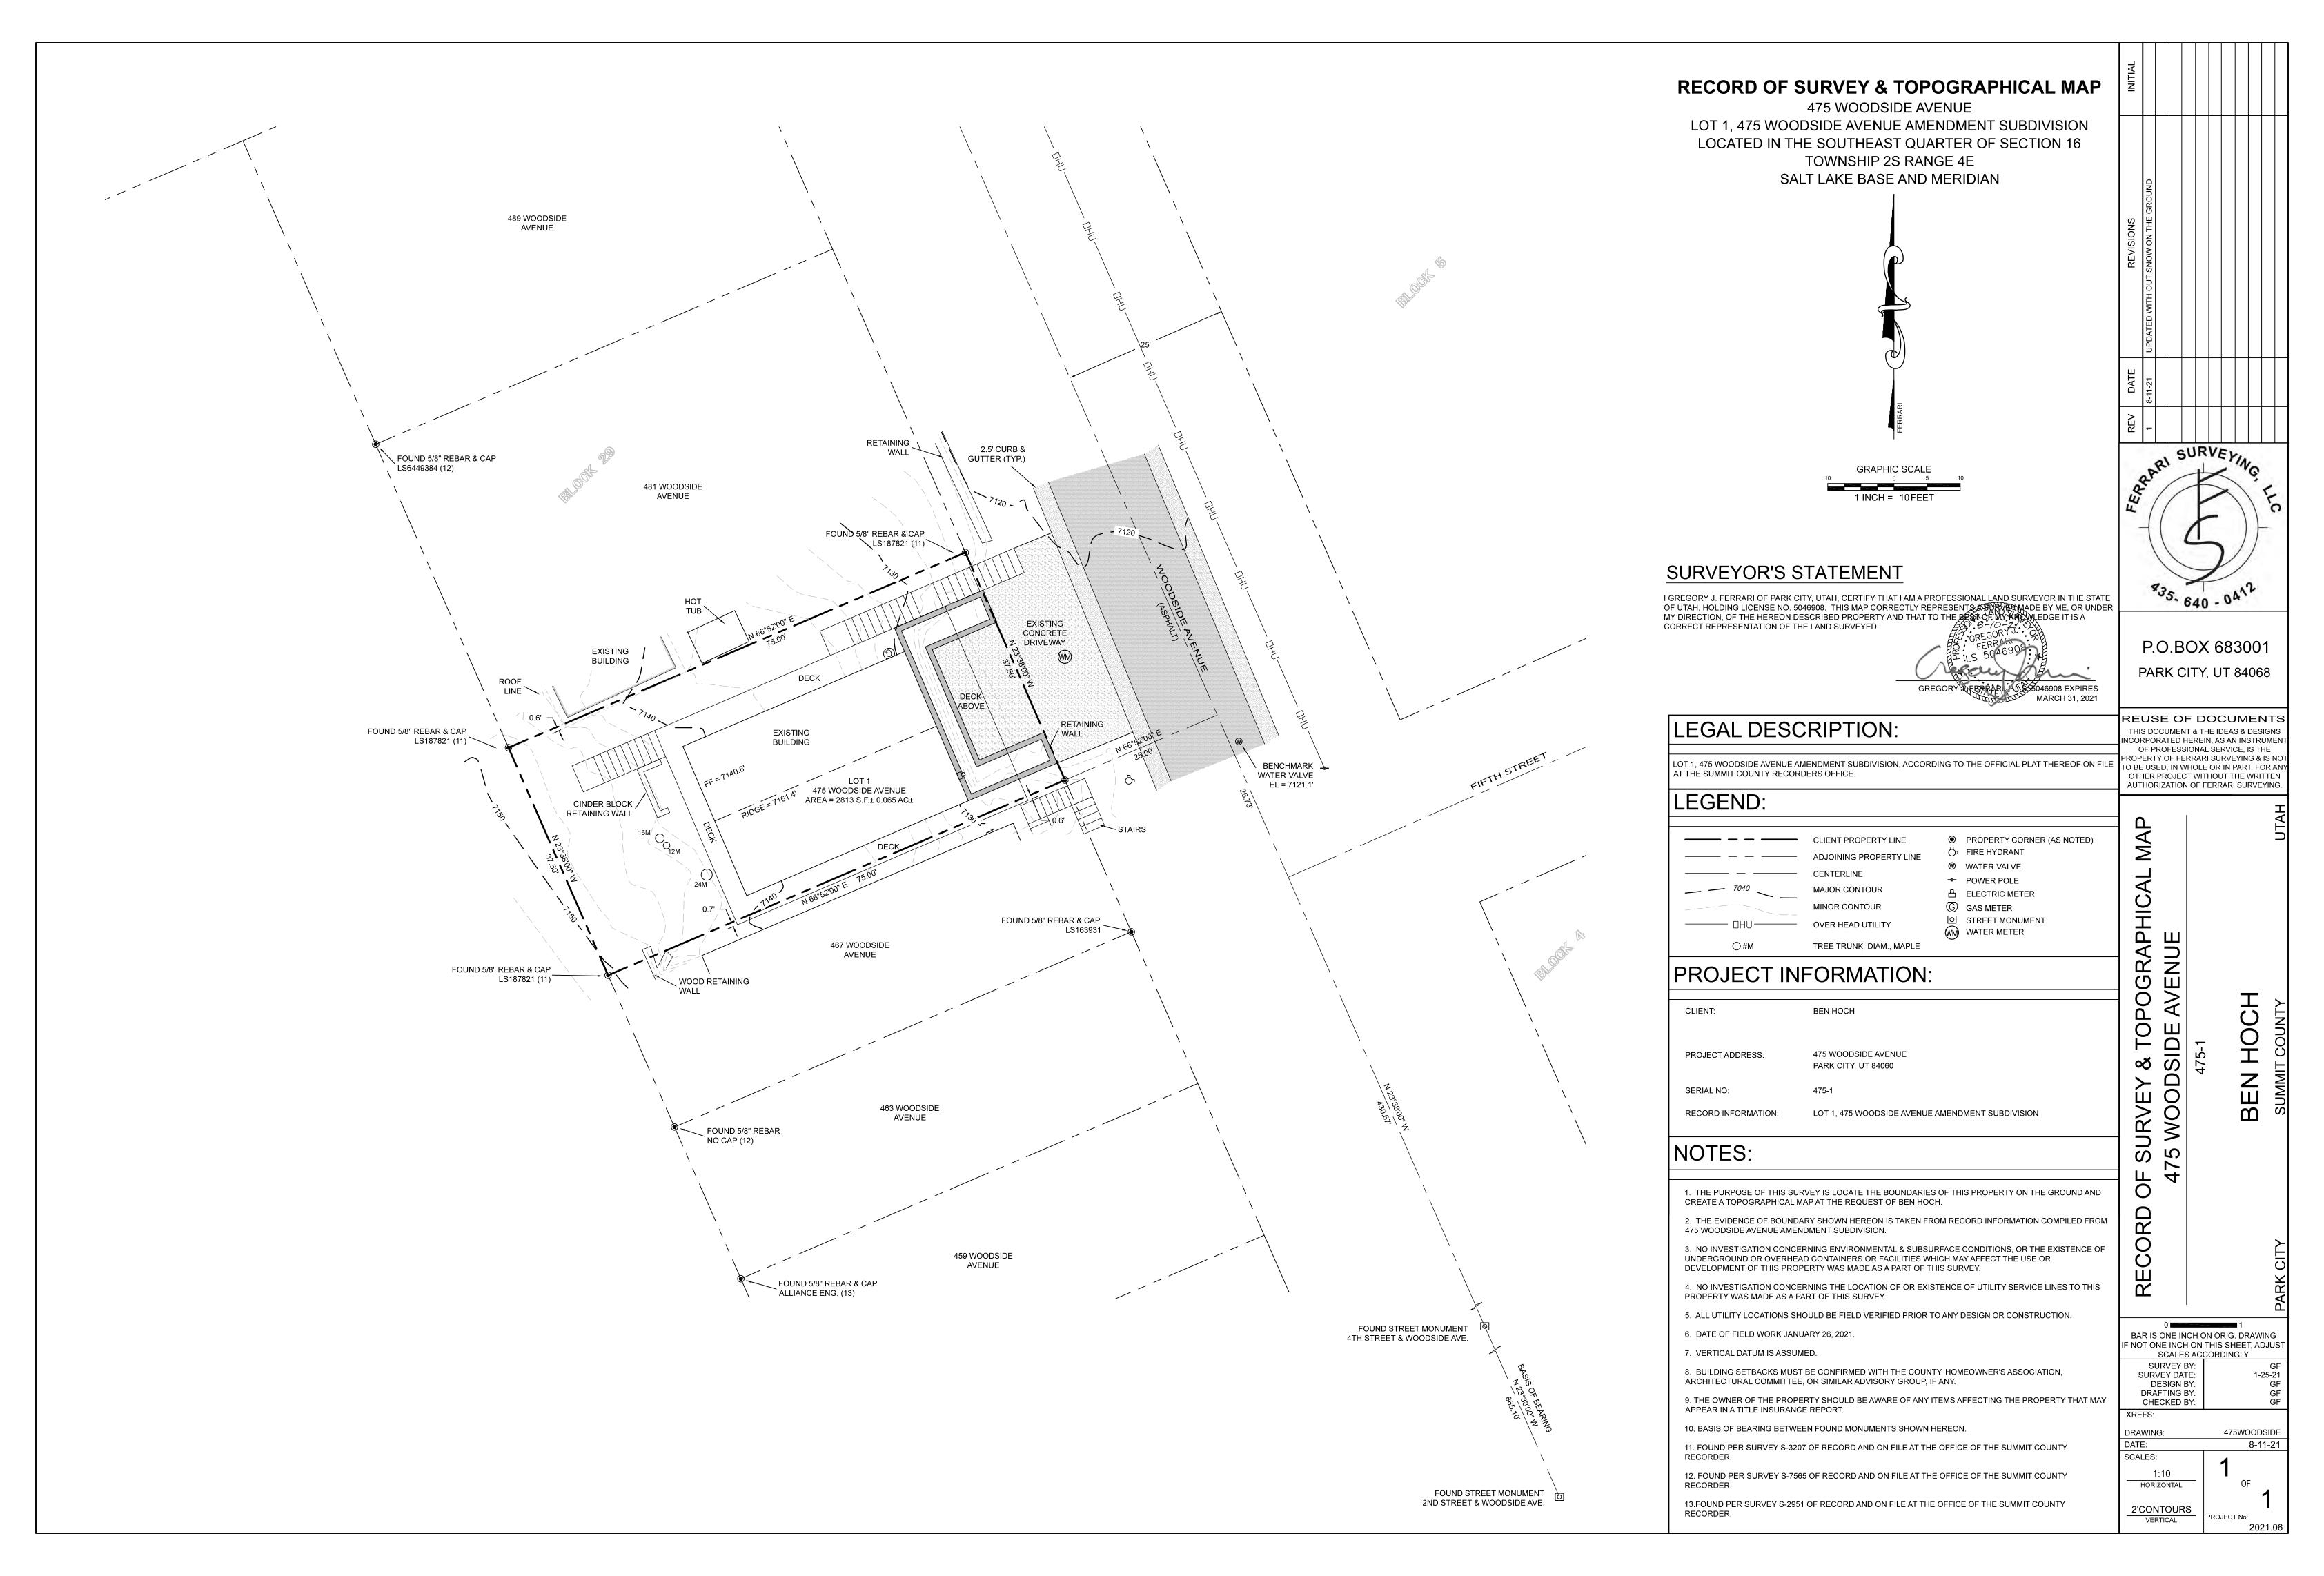

PLAT AMENDMENT AND RELORD OF SURVEY 475 WOODSIDE AVENUE AMENDMENT

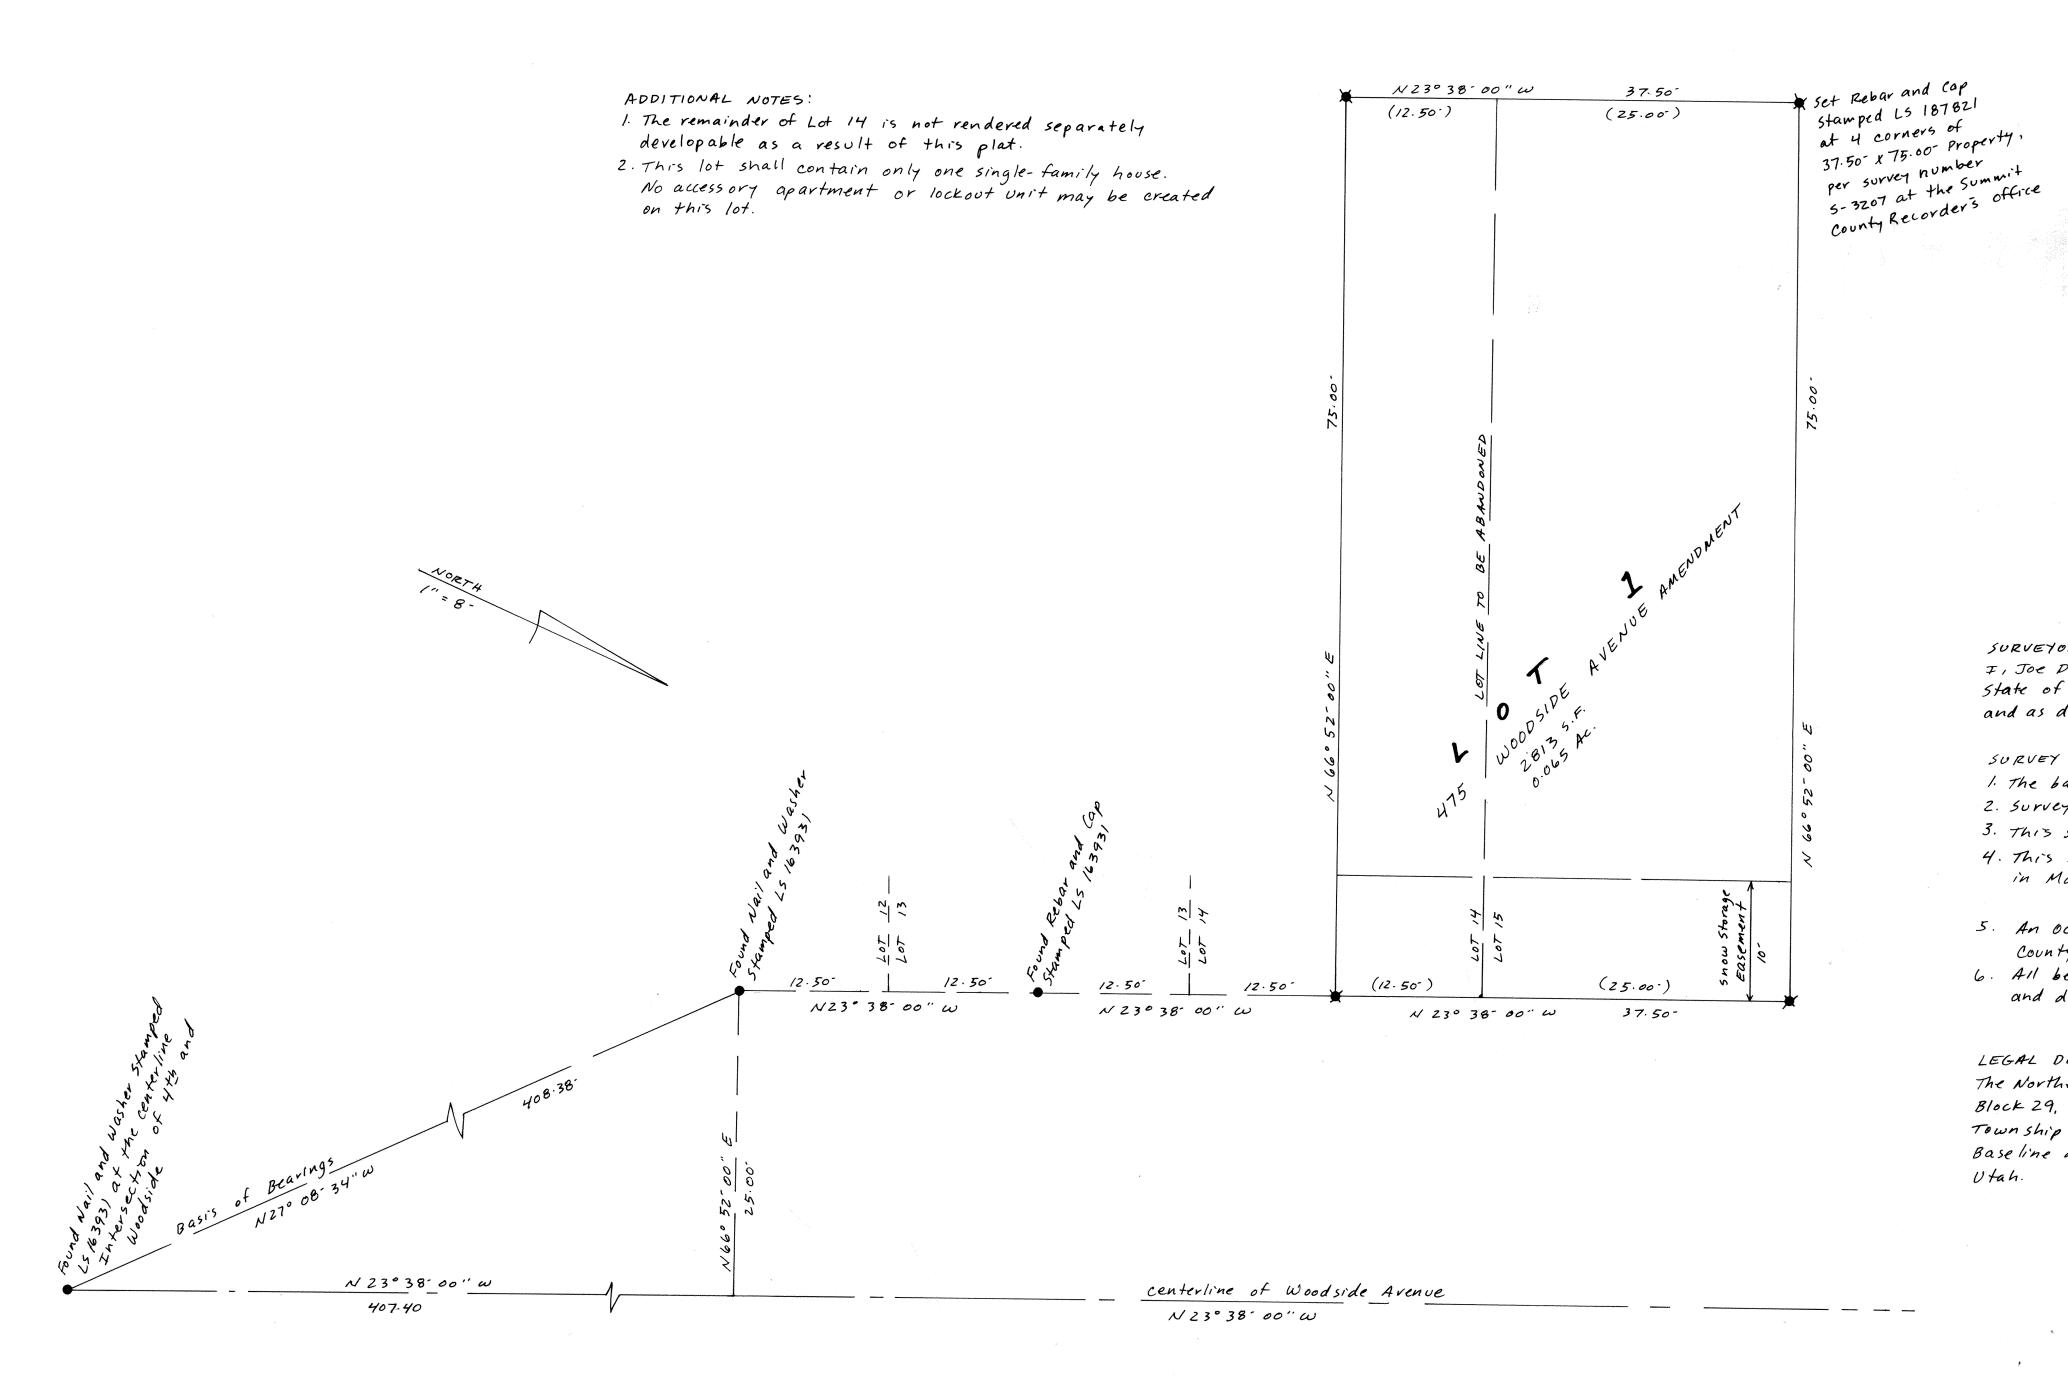

OWNER'S DEDICATION AND CONSENT TO RECORD: Know all men, by these present, that I, Adele D. Langton, as Trustee of the Adele D. Langton Revocable Trust dated June 25, 1992, the owner of the hereon described property, hereinafter to be known as 475 woodside Avenue, certify that I have caused this survey to be made, and the Plat to be prepared, and I do hereby consent to the recordation of this survey and Plat Amendment. The owner hereby offers an irrevocable dedication of easements for public purposes as shown on this plat to Park City in accordance with an irrevocable offer of dedication.

Adele D. Langton, as Trustee of the Adele D. Langton

Revocable Trust dated June 25, 1992.

ACKNOWLEDGEMENT! State of Utah

county of summer on this 24 th day of June, 1999, personally appeared before me, the undersigned notary public in and for said state and County, Adele D. Langton, as Trustee of the Adele D. Langton Revocable Trust dated June 25, 1992, who after being duly sworn, acknowledged to me that she is the owner of the hereon described property, and that she signed the above owner's dedication and consent to record freely and voluntarily.

My Commission Expires

SURVEYOR'S CERTIFICATION!

I, Joe Phaenens, hold license number 187821 as prescribed by the laws of the State of Utah, and certify that I have made a survey of the property shown hereon and as described in the notes and legal description below.

SURVEY NOTES:

1. The basis of bearings is as shown.

2. Survey monuments were found or set as shown.

3. This survey was requested by Adele Langton.

4. This survey was performed in October, 1998, and the Plat Amendment was prepared

5. An october, 1998 survey of the property was recorded as #5-3207 at the summit County Recorder's Office.

6. All bearings and distances shown were measured and are equal to the bearings and distances of the Park City survey and/or other survey's recorded for Block 29.

LEGAL DESCRIPTION:

The Northerly one-half of Lot 14 and all of Lot 15, Block 29, Park City Survey, located in Section 16, Township 2 South, Range 4 East, Salt Lake Baseline and Meridian, park City, Summit County, Utah.



Date 7-7-99

City Council Approved by the Park City Council on this 27th day of MAN, 1999.

City Planning Commission Approved by the Park City Planning Commission on this 30 day of JUNE, 1999.

City Engineer Approved by the Park City Engineer on this 24th day of JUNE,

city Attorney on this 6TH day of Juy, 1999.

Approved as to form by the Park

City Attorney

Sewer Drstrict Reviewed for conformance to Snyderville Basin Sewer Improvement District standards on this 17 h day of UNC, 1999.

state of Utah. Time 15:53 PM County of Summit. Fee 31.00 Recorded and filed at the request of FIRST AMERICAN TITLE

County Recorder

Recorded

Number 543463

surveyed by: On The Map Land Surveying P.O. BOX 3864 Park City, UT 84060 647-9826

475 WOODSIDE AVENUE **AMENDMENT**